


**HIGH WIND AREA AND ALPINE CONDITIONS
PROJECT SITE ELEVATION IS 4,000 + FEET**

1 ROOF PLAN
1/8" = 1'-0"

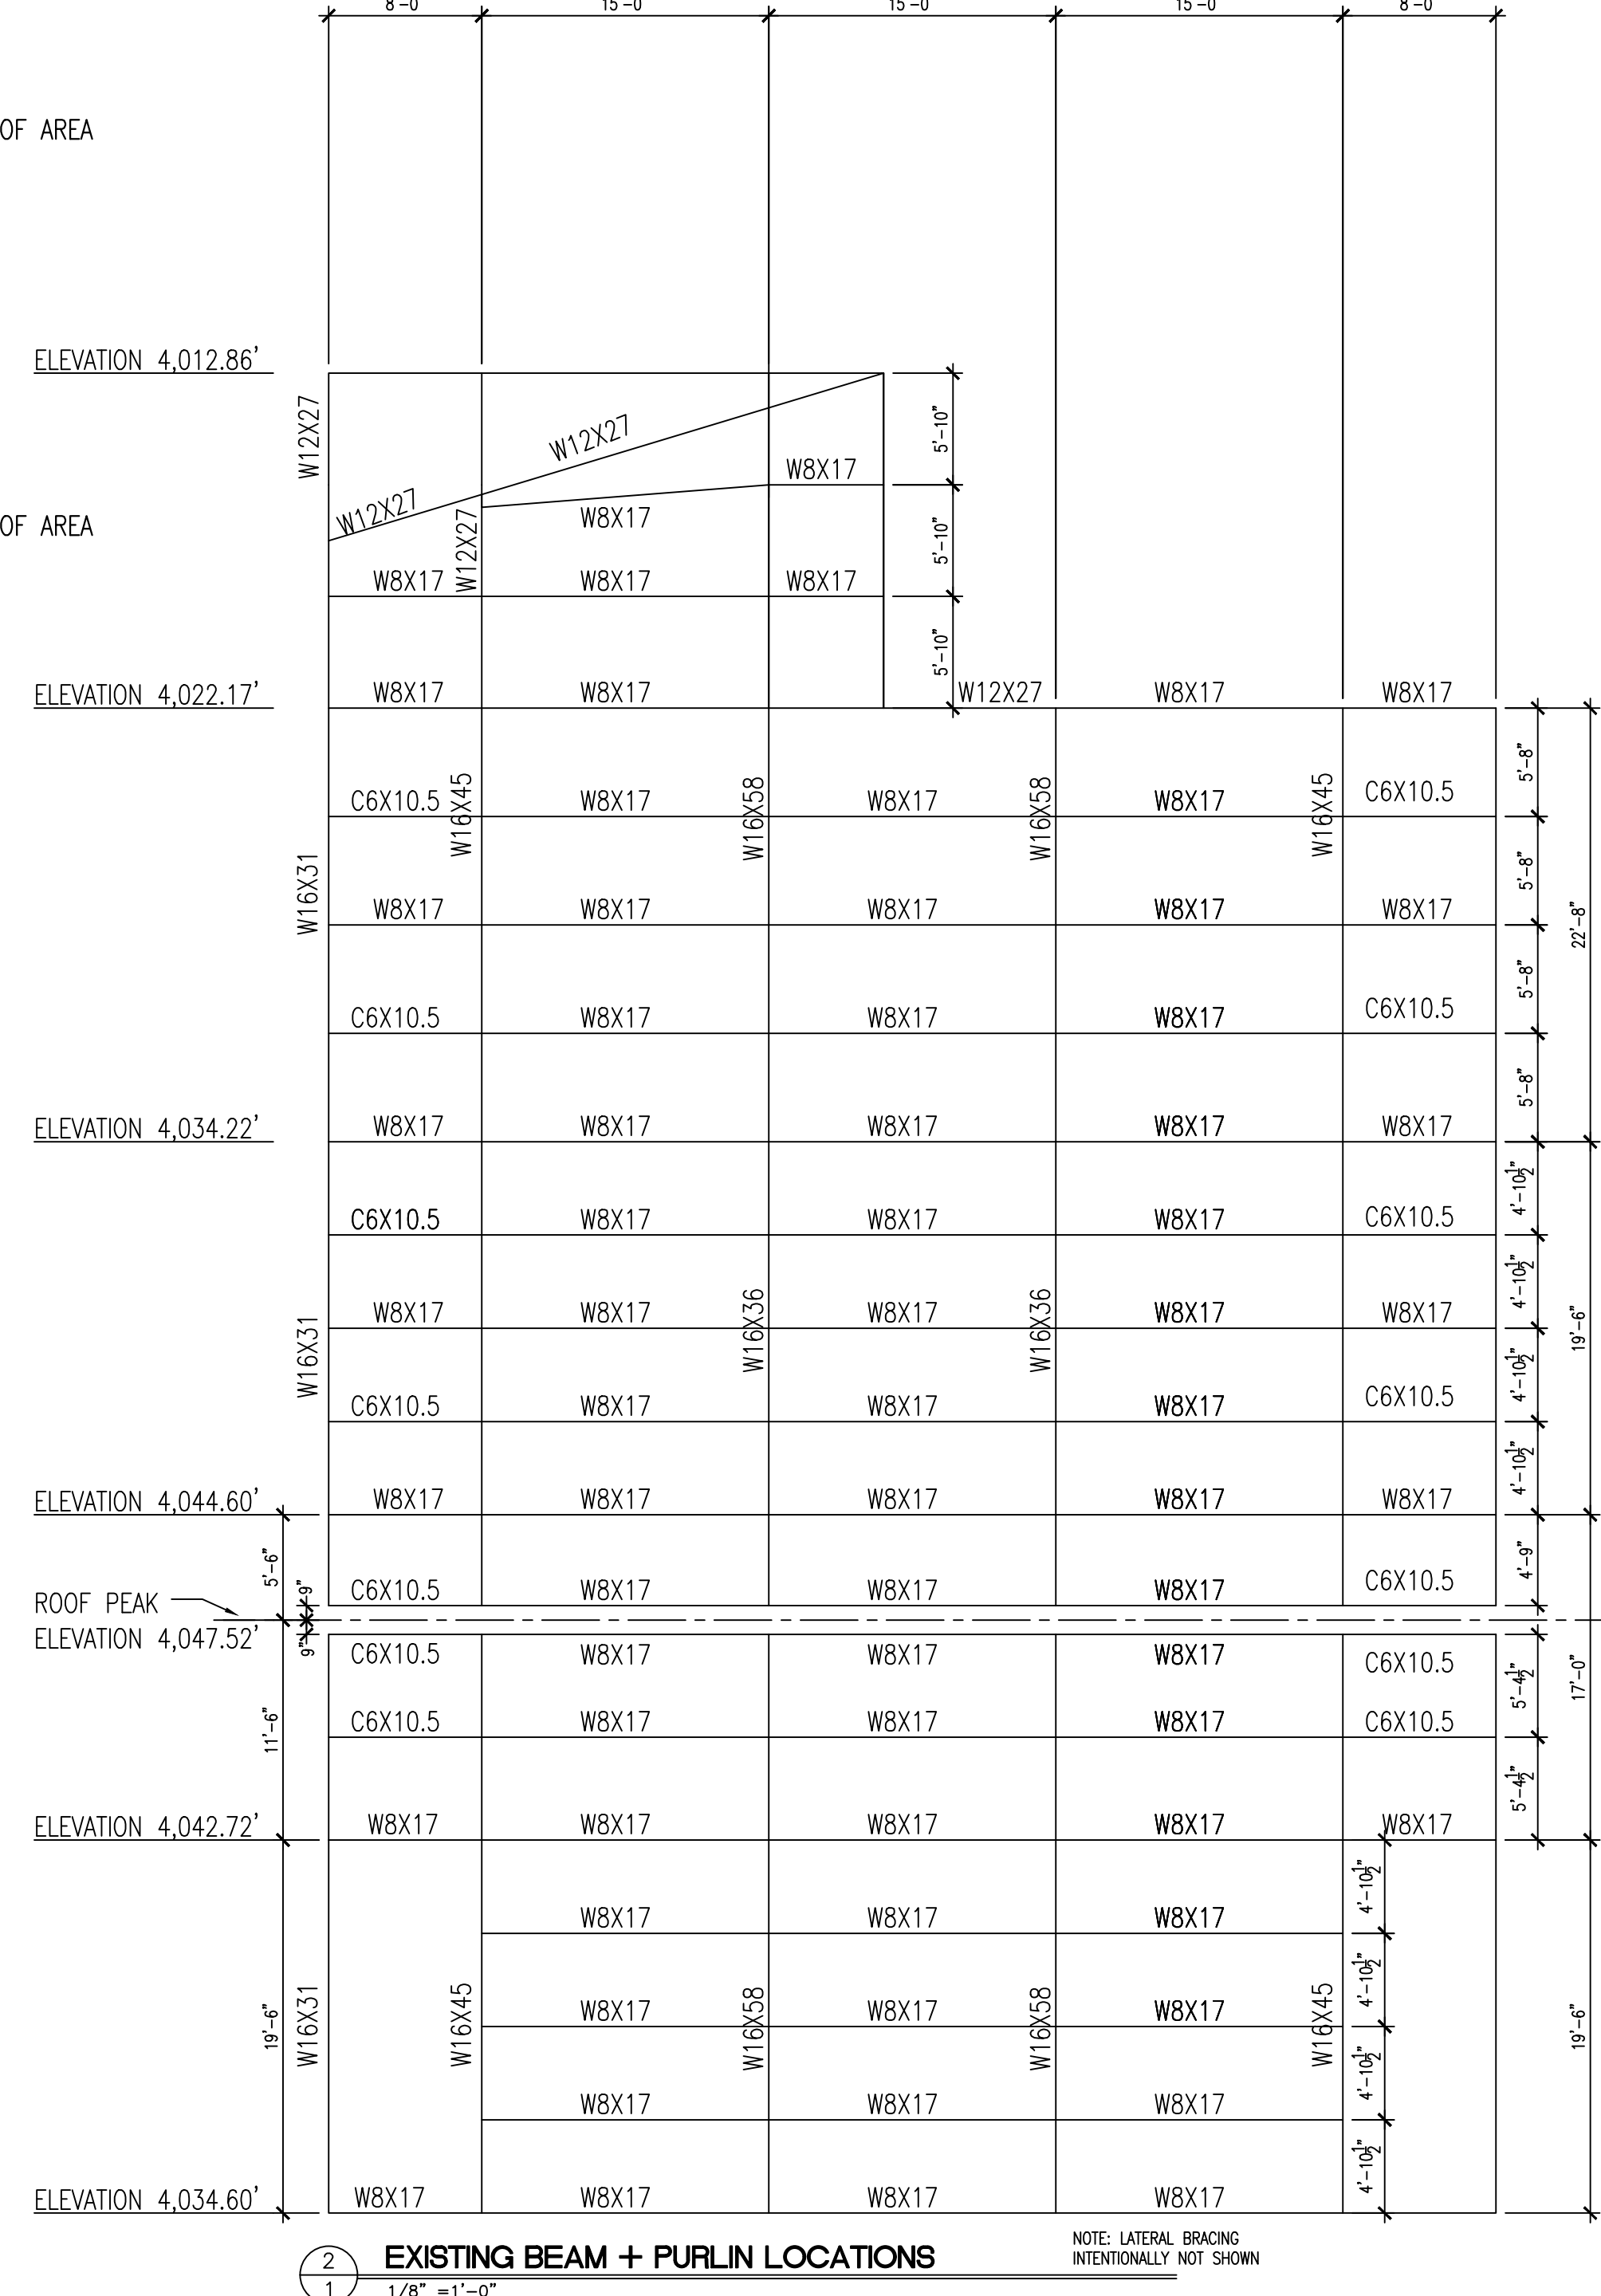

2 EXISTING BEAM + PURLIN LOCATIONS
1/8" = 1'-0"

NOTE: LATERAL BRACING INTENTIONALLY NOT SHOWN

- NOTES:**
1. REMOVE EXISTING METAL ROOF PANELS.
 2. INSTALL NEW MBCI 7.2 PANELS 22 GAUGE IN ACCORDANCE TO MANUFACTURER'S INSTRUCTIONS FOR HIGH WIND AREAS.
 3. INSPECT EPDM ROOFING, REPAIR OR REPLACE AS REQUIRED.
 4. REMOVE EXISTING ASPHALT SHINGLE ROOFING.
 5. INSTALL NEW ASPHALT SHINGLE ROOFING IN ACCORDANCE WITH MANUFACTURER'S INSTRUCTIONS FOR HIGH WIND AREAS.

**METAL & ASPHALT SHINGLE ROOF REPLACEMENT
CANNON MTN AERIAL TRAMWAY SUMMIT BUILDING**

DATE: OCT 15, 2021
PROJECT # CAP-2139
APPROVED BY: EDWARD MUSSEY
SCALE 1/8" = 1'-0"
DRAWN BY: EDWARD MUSSEY



STATE OF NEW HAMPSHIRE
DEPARTMENT OF NATURAL AND CULTURAL RESOURCES
OPERATIONS PLANNING & PROJECT MANAGEMENT
FRANCONIA NOTCH STATE PARK
LOCATION, NEW HAMPSHIRE