MOLLIDGEWOCK STATE PARK

NEW VISITORS RECEPTION CENTER - 30% DESIGN

1437 Berlin Road Errol, NH 03570

SHEET LIST

	<u>-</u>
SHEET NO.	SHEET TITLE
G0.00 L0.01	COVER SHEET LANDSCAPE GENERAL LEGEND & NOTES
C1.00 C1.10	EXISTING CONDITIONS DEMOLITION PLAN
C2.00	CIVIL SITE PLAN
C3.00 C3.10	EROSION CONTROL DETAILS CIVIL DETAILS
L1.00	SITE PLAN
A1.01 A1.02 A2.01 A3.01	MAIN FLOOR PLAN ROOF PLAN EXTERIOR ELEVATIONS BUILDING & WALL SECTIONS
M1.01M E1.01M P1.01M	MECHANICAL PLAN AND DETAILS ELECTRICAL PLAN AND DETAILS PLUMBING PLAN AND DETAILS

SITE





ISE GROUP

tel: 802.862.0098 fax: 802.865.2440 www.segroup.com

Mollidgewock State Park 1437 Berlin Road Errol, NH 03579

30% DESIGN

Graphic Scale

Drawn By: KS

	Issues:					
No.	Description	Date				
1	Name	00/00/00				

COVER SHEET

G0.00

Project Number: 23045001 File: I0.00-cover sheet.dwg

LANDSCAPE ARCHITECT CIVIL ENGINEER SE GROUP 1 MILL STREET, SUITE 190 BURLINGTON, VT 05401

HORIZONS ENGINEERING 8836 POMFRET ROAD, SUITE 2A 6 CENTRAL HOUSE ROAD NORTH POMFRET, VT 05053

ARCHITECT SAMYN-D'ELIA ARCHITECTS, P.A. HOLDERNESS, NH 03245

GENERAL NOTES

 ALL CONTRACTORS ARE REQUIRED TO CONTACT DIG SAFE, THE
 MUNICIPALITIES PUBLIC WORKS DEPARTMENT, AND ANY OTHER PUBLIC OR PRIVATE AGENCIES NECESSARY FOR UTILITY LOCATION PRIOR TO ANY CONSTRUCTION.

2. UNDERGROUND UTILITIES WILL EXIST THROUGHOUT THIS SITE AND MUST BE 2. ONDERGROUND IT INTESS WILL ZAST I FIREODOUGH IT IN STEAM MUST BE ALD MUST BY LOCATED PRIOR TO CONSTRUCTION, WHERE UNDERGROUND UTILITIES EXIST, FIELD ADJUSTMENT MUST BE APPROVED BY A REPRESENTATIVE OF THE OWNER PRIOR TO INSTALLATION, NEITHER THE OWNER NOR THE LANDSCAPE ARCHITECT ASSUMES ANY RESPONSIBILITY WHATSCEVER, IN RESPECT TO THE CONTRACTORS ACCURACY IN LOCATING THE INDICATED ELEMENTS ON THE

3. THE LANDSCAPE ARCHITECT AND CONSULTANTS DO NOT WARRANT OR 3. THE LANDSCAPE ARCHITECT AND CONSULTAINS DO NOT WARRANT OR GUARANTEE THE ACCURACY AND COMPLETENESS OF THE WORK PRODUCT THEREIN BEYOND A REASONABLE DILIGENCE. IF ANY MISTAKES, OMISSIONS, OR DISCREPANCIES ARE FOUND TO EXIST WITH THE WORK PRODUCT, THE LANDSCAPE ARCHITECT SHALL BE PROMPTLY NOTIFIED SO THAT THEY MAY HAVE THE OPPORTUNITY TO TAKE ANY STEPS RECESSARY TO RESOLVE THE ISSUE. FAILURE TO PROMPTLY NOTIFY THE OWNER AND THE LANDSCAPE ARCHITECT OF SUCH CONDITIONS SHALL ABSOLVE THEM FROM ANY RESPONSIBILITY FOR THE CONSEQUENCES OF SUCH FAILURE, ACTIONS TAKEN WITHOUT THE KNOWLEDGE AND CONSENT OF THE OWNER AND THE LANDSCAPE ARCHITECT, OR IN CONTRADICTION TO THE OWNER AND THE LANDSCAPE ARCHITECTS WORK PRODUCT OR RECOMMENDATIONS, SHALL BECOME THE RESPONSIBILITY NOT OF THE OWNER AND THE LANDSCAPE ARCHITECT BUT FOR THE PARTIES RESPONSIBLE FOR THE TAKING OF SUCH ACTION.

4. IT IS SE GROUP'S UNDERSTANDING THAT THE BASE INFORMATION WAS PROVIDED BY A LICENSED LAND SURVEYOR. THE CONTRACTOR SHALL NOTIFY THE OWNER'S REPRESENTATIVE AND LANDSCAPE ARCHITECT OF ANY DISCREPANCIES AS SOON AS THEY ARE DISCOVERED AND PRIOR TO ANY ACTION

5. CONTRACTOR TO DEVELOP PLAN WITH OWNER OR OWNERS REPRESENTATIVE FOR PROTECTION OF EXISTING TREES TO REMAIN.

LAYOUT NOTES

1. THE CONSULTANT DRAWINGS ARE SUPPLEMENTARY TO THE LANDSCAPE ARCHITECTURAL DRAWINGS. IT SHALL BE THE RESPONSIBILITY OF THE GENERAL CONTRACTOR TO CHECK WITH WITH LANDSCAPE ARCHITECTURAL DRAWINGS BEFORE INSTALLATION OF CONSULTANT WORK, SHOULD THERE BE A DISCREPANCY BETWEEN THE LANDSCAPE ARCHITECTURAL DRAWINGS AND THE DRAWINGS OF THE CONSULTING ENGINEERS, IT SHALL BE BROUGHT TO THE LANDSCAPE ARCHITECT'S ATTENTION FOR CLARIFICATION, ANY WORK INSTALLED IN CONFLICT WITH ANY OF THE DRAWINGS SHALL BE CORRECTED AT NO EXPENSETO THE OWNER OR DESIGN CONSULTANTS.

2. ALL SYMBOLS, ABBREVIATIONS AND MATERIAL INDICATIONS ARE CONSIDERED TO BE CONSTRUCTION STANDARDS. IF THE CONTRACTOR HAS QUESTIONS REGARDING THEIR EXACT MEANING, THE CONTRACTOR SHALL REQUEST THAT THE LANDSCAPE ARCHITECT ISSUE A CLARIFICATION.

3. DO NOT SCALE DRAWINGS. DIMENSIONS MISSING FROM PLANS OR NEEDED FOR EXECUTION OF THE WORK SHALL BE CLARIFIED OR PROVIDED BY THE LANDSCAPE ARCHITECT BEFORE THE WORK IS INSTALLED.

- ALL DIMENSIONS ARE TO FACE OF FINISH MATERIAL, UNLESS
 OTHERWISE NOTED.
- TAKE ALL DIMENSIONS PERPENDICULAR TO ANY REFERENCE LINE,
- WORK LINE, CENTERLINE, OR FACE OF BUILDING/STRUCTURE ALL DIMENSIONS CALLED OUT AS "EQUAL" ARE CONSIDERED
- EQUIDISTANT MEASUREMENTS.

4. REFERENCE TO NORTH IS TRUE NORTH

5, REFERENCE TO SCALE IS FOR FULL SIZED DRAWINGS, NOT REDUCED PLANS, DO NOT SCALE FROM DRAWINGS.

6. ANY CONFLICTS IN WHICH THE METHODS OR STANDARDS OF INSTALLATION OR MATERIALS SPECIFIED DO NOT EQUAL OR EXCEED THE REQUIREMENTS OF THE LAWS OR ORDINANCES GOVERNING THE PROJECT, THE LAWS AND ORDINANCES HALL TAKE PRECEDENCE. NOTIFY THE LANDSCAPE ARCHITECT OF ALL

7. THE CONTRACTOR SHALL MAKE CERTAIN THAT THE WORK OF THE NEW CONSTRUCTION WILL NOT OBSTRUCT FIRE DEPARTMENT ACCESS TO NEARBY BUILDINGS. EXITS SHALL BE MAINTAINED CLEAR OF ALL OBSTRUCTIONS.

8. THE CONTRACTOR SHALL VERIFY THE EXISTING CONDITIONS AND NOTIFY THE LANDSCAPE ARCHITECT OF ANY CONDITIONS VARYING FROM INFORMATION HEREIN PRIOR TO PROCEEDING WITH WORK.

9. TO ESTABLISH LANDSCAPE ARCHITECTURAL INTENT, EVERY ATTEMPT HAS BEEN MADE TO IDENTIFY MOST CONDITIONS.

10. CONTRACTOR TO COMMUNICATE WITH CIVIL ENGINEER / SURVEYOR REGARDING SURVEY HORIZONTAL AND VERTICAL CONTROL. CIVIL ENGINEER CAN PROVIDE INFORMATION REQUIRED FOR SITE LAYOUT, AS NECESSARY.

PLANTING NOTES

1. ALL PLANT MATERIAL SHALL BE INSTALLED AS PER THE CONTRACT DOCUMENTS AND SPECIFICATIONS.

2. THE LANDSCAPE CONTRACTOR SHALL BE RESPONSIBLE FOR COORDINATING WITH THE GENERAL CONTRACTOR AND IF NECESSARY OTHER SUB CONTRACTORS AS REQUIRED TO ACCOMPUSH PLANT MATERIAL INSTALLATION.

3. THE LANDSCAPE CONTRACTOR IS RESPONSIBLE TO LOCATE ALL UNDERGROUND UTILITIES PRIOR TO STARTING WORK.

4. PLANT MATERIAL INSTALLATION SHALL NOT OCCUR BEFORE ROUGH GRADING HAS BEEN COMPLETED AND APPROVED BY LANDSCAPE ARCHITECT.

5 ALL PLANT MATERIAL SHALL CONFORM TO THE GUIDELINES ESTABLISHED BY THE CURRENT AMERICAN STANDARD FOR NURSERY STOCK, PUBLISHED BY THE
AMERICAN ASSOCIATION OF NURSERYMAN. ALL TREES AND SHRUBS OF THE SAME SPECIES AND SIZE SHALL HAVE MATCHING HEIGHT AND FORM UNLESS OTHERWISE NOTED ON THE PLANS.

6. CONTRACTOR SHALL SUPPLY ALL PLANT MATERIAL IN QUANTITIES SUFFICIENT TO COMPLETE THE PLANTINGS SHOWN IN THE CONTRACT DOCUMENTS. DISCREPANCIES IN QUANTITIES SHALL BE BROUGHT TO THE ATTENTION OF THE LANDSCAPE ARCHITECT IMMEDIATELY.

7. STAKE LOCATIONS OF PROPOSED PLANT MATERIAL PRIOR TO EXCAVATING 7. STARE LOCATIONS OF PROPOSED PLANT MATERIAL PRIOR TO EXCAVATING PLANT PTS. LOCATION OF ALL PLANT PITS TO BE DETERMINED IN THE FIELD WITH THE LANDSCAPE ARCHITECT. PAINT OUTLINES FOR PLANT BEDS AND GROUND COVER, FINAL LAYOUT TO BE APPROVED BY LANDSCAPE ARCHITECT.

8. CONTRACTOR SHALL FURNISH PLANT MATERIAL FREE OF PESTS OR PLANT DISEASES. PRESELECTED OR "TAGGED" MATERIAL MUST BE INSPECTED BY THE CONTRACTOR AND CERTIFIED PEST AND DISEASE FREE. IT IS THE CONTRACTOR'S RESPONSIBILITY TO WARRANTY ALL PLANT MATERIAL BASED ON THE CONTRACT DOCUMENTS AND SPECIFICATIONS.

9. CONTRACTOR SHALL BE RESPONSIBLE FOR REPLACEMENT OF ANY EXISTING HARDSCAPE OR SOFTSCAPE MATERIALS DAMAGED DURING PLANTING

10. ALL TREES. PLANT BEDS AND GROUNDCOVER SHALL BE COVERED WITH 2" OF C BARK MULCH AS NOTED IN THE SPECIFICATIONS.

11, AREAS SHOWN AS GROUNDCOVER AT THE BASE OF TREES AND SHRUBS MUST CONFORM TO THE FOLLOWING CRITERIA. THERE SHALL BE NO GROUND COVER INSTALLED AT THE BASE OF TREES OR SHRUBS AS FOLLOWS:

a. 4 FOOT RADIUS AROUND EVERGREENS.

- 3 FOOT RADIUS AROUND DECIDUOUS TREES.
- 2 FOOT RADIUS AROUND LARGE SHRUBS.

12. ALL SHRUBS AND GROUNDCOVER SHALL BE PLANTED USING A TRIANGULATED METHOD, REFER TO PLANT MATERIAL INSTALLATION DETAILS.

GRADING NOTES

1. REFER TO THE CIVIL ENGINEER'S DRAWINGS FOR GENERAL SITE GRADING AROUND THE PROJECT SITE.

LEGEND

-

GB

TC +

BC +

FC +

HP +

RE +

CB +

TD +

PD +

EXISTING CONTOURS

GRADE BREAK

BOTTOM OF WALL

BOTTOM OF CURB

BOTTOM OF RAMP

TOP OF CURB

FLUSH CURB

HIGH POINT LP + LOW POINT

RIM ELEVATION

TRENCH DRAIN

PLANTER DRAIN SUB SURFACE PLANTER DRAIN

CATCH BASIN

TR + TOP OF RAMP BR +

AD + AREA DRAIN

(430.50) + EXIST, SPOT GRADE

TS + TOP OF STEP BS + BOTTOM OF STEP


TW + TOP OF WALL BW +

430,50 + SPOT GRADE

PROPOSED CONTOURS

2. REFER TO THE LANDSCAPE ARCHITECT'S DRAWINGS FOR MICRO GRADING AROUND THE PROJECT SITE. MICRO GRADING IS RELATED TO FINISH ELEVATIONS OF HARDSCAPE SURFACES, I.E. SITE WALLS, TERRACES AND WALKS, UNLESS OTHERWISE NOTED.

LANDSCAPE ARCHITECTURAL SYMBOLS

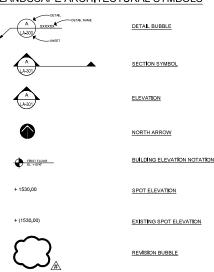

LANDSCAPE DRAWING ABBREVIATIONS

DIMENSION

NOTE: ALL DIMENSIONS ARE TO OR FROM STRUCTRUAL GRID LINES OR FACE OF

FINISH MATERIAL ILO N

@	AT	HP	HIGH POINT
AD	AREA DRAIN	HT	HEIGHT
AL	ALIGN	I.D.	INSIDE DIAMETER
ALT	ALTERNATE	LP	LOW POINT
ASPH	ASPHALT	MAX	MAXIMUM
BC	BOTTOM OF CURB	MFR	MANUFACTURER
BLDG	BUILDING	MIN	MINIMUM
BS	BOTTOM OF STEP	NIC	NOT IN CONTRACT
BW	BOTTOM OF WALL	o.c.	ON CENTER
CB	CATCH BASIN	O.D.	OUTSIDE DIAMETER
CJ	CONTROL JOINT	QTY	QUANTITY
CL	CENTERLINE	R	RAD I US
CONC	CONCRETE	REINF	REINFORCED
CONST	CONSTRUCTION	REQ	REQUIRED
CONT	CONTINUOUS	SPECS	SPECIFICATIONS
CTR	CENTER	SS	STAINLESS STEEL
DIA	DIAMETER	STD	STANDARD
DIM	DIMENSION	TD	TRENCH DRAIN
DWG	DRAWING	TC	TOP OF CURB
EA	EACH	TS	TOP OF STEP
EJ		TW	TOP OF WALL
ELEV	ELEVAT I ON	TYP	TYPICAL
EOP	EDGE OF PAVEMENT	U.O.N.	
EQ	EQUAL	VIF	VERIFY IN FIELD
EW	EACH WAY	W/	WITH
FC	FLUSH CURB	W/O	WITHOUT
FF	FINISH FLOOR	WWF	WELDED WIRE FABRIC

SE GROUP tel: 802.862.0098 fax: 802.865.2440 www.segroup.com

NH STATE PARKS Campground Expansion Project PII

Mollidgewock State Park 1437 Berlin Road Errol, NH 03579

30% DESIGN

Granhic Scale

Date: August 25, 2023


Drawn By: KS


No.	Description	on Date	
1	Name	00/00/00	


GENERAL EGEND & NOTES

L0.00

Project Number: 23045001 File: I0.00-cover sheet.dwg

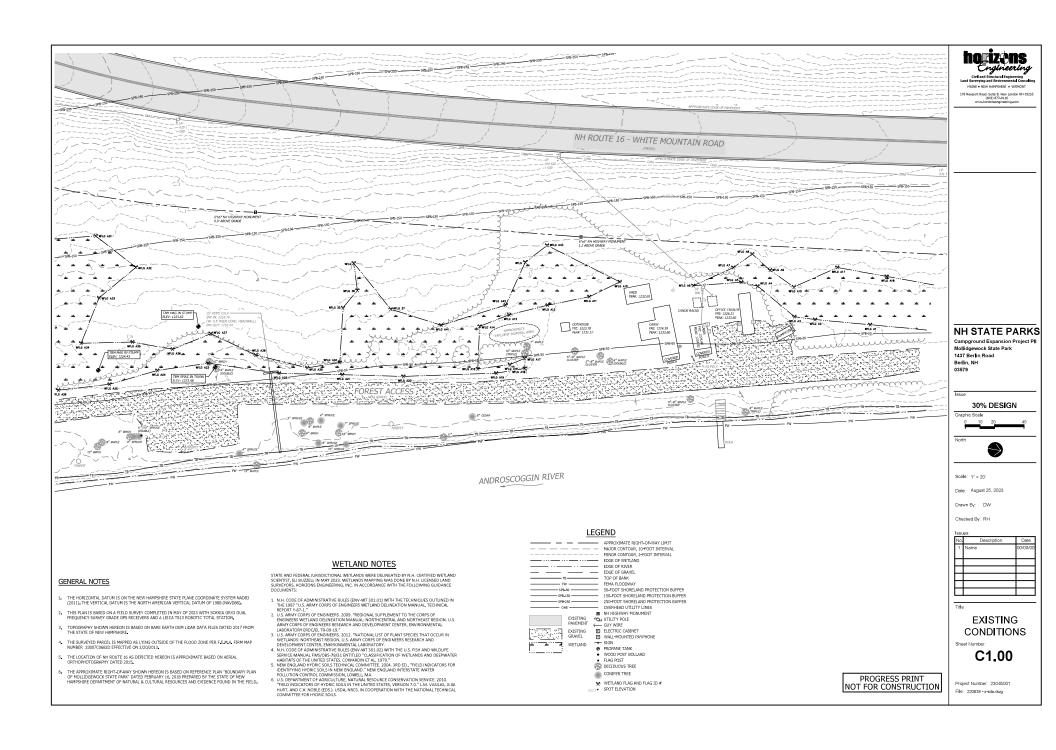

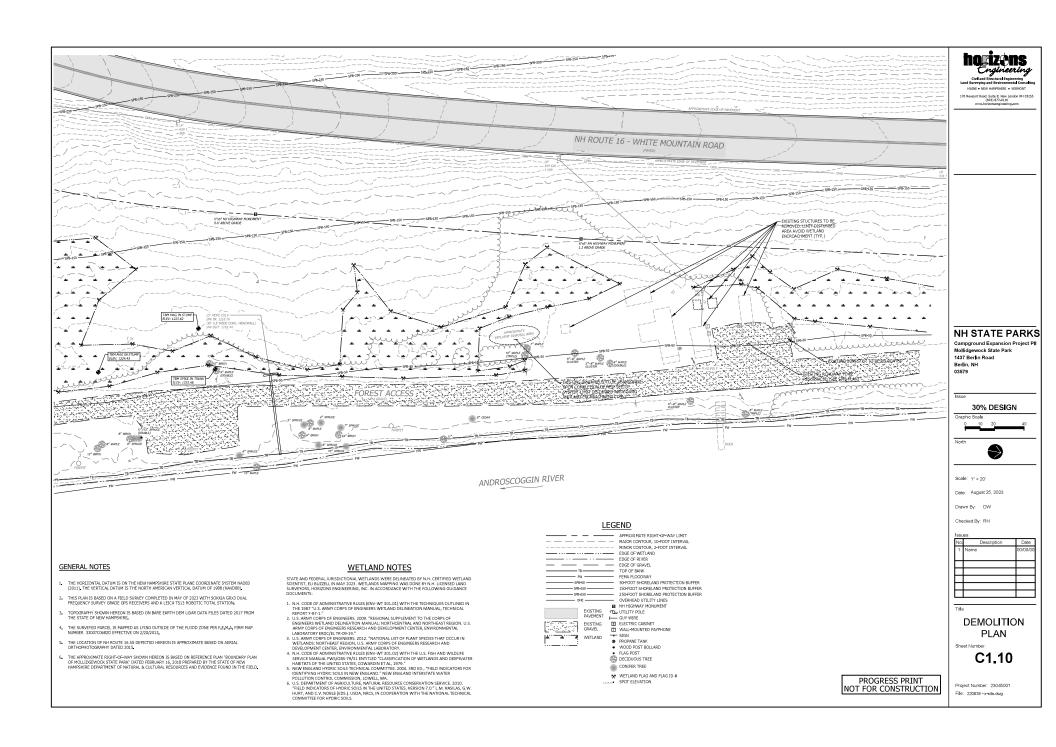

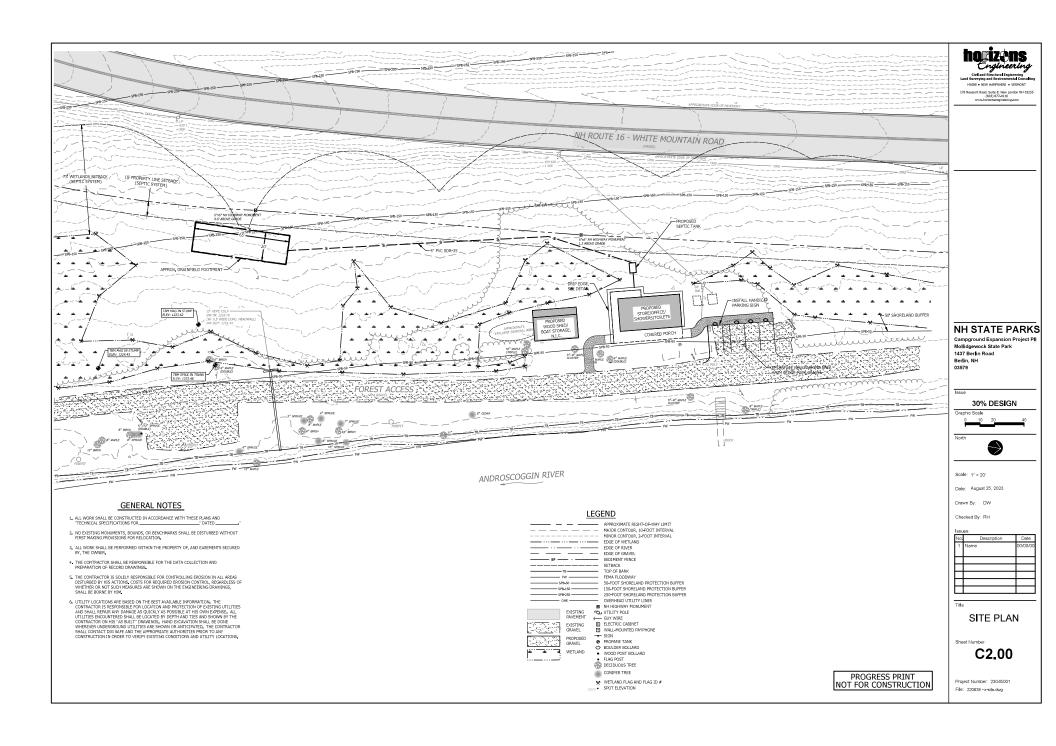

SEEDING RECOMMENDATIONS

GRADING AND SHAPING
A SLOPES SHALL NOT BE STEEPER THAN 2:1; 3:1 SLOPES OR FLATTER ARE PREFERRED, WHERE MOWING WILL BE DONE, 3:1 SLOPES OR FLATTER ARE RECOMMENDED.

2. SEEDBED PREPARATION

A. SURFACE AND SEEPAGE WATER SHOULD BE DRAINED OR DIVERTED FROM THE SITE TO PREVENT DROWNING OR WINTER KILLING OF THE PLANTS.

B. STONES LARGER THAM 4 INCHES AND TRACH SHOULD BE REMOVED BECAUSE THEY INTERFERE WITH SECOND AND FURTHER MAINTENANCE OF THE AREA, WEREE FRESHEE, THE SOIL SHOULD BE AMENDED WITH DOGGMENT WATTER MAINTENANCE TO REPORT A REPORT OF A DEPTH OF A DOGGMENT OF A STONES TO A DEPTH OF A DOGGMENT OF A STONES OF A DOGGMENT OF A STONES OF A DOGGMENT OF A STONES OF A DOGGMENT OF A DOGGMEN

ESTABLISHING VEGETATION
 A. LIME AND FERTILIZES SHOULD BE APPLIED PRIOR TO OR AT THE TIME OF SEEDING AND INCORPORATED IN
THE SOIL. INIDS AND AMOUNTS OF LIME AND FERTILIZER SHOULD BE BASED ON AN EVALUATION OF SOIL
TESTS. WHEN A SOIL TEST IS NOT AVAILABLE, THE FOLLOWING MINIMUM AMOUNTS SHOULD BE APPLIED:

AGRICULTURAL LIMESTONE, 2 TONS PER ACRE OR 100 LBS. PER 1,000 SO. FT.

MITROGEN (N), 50 LBS. PER ACRE OR 1,1 LBS. PER 1,000 SO. FT.

PHOSPHATE (P.O.), 100 LBS. PER ACRE OR 2,2 LBS. PER 1,000 SO. FT.

POTASH (K,0), 100 LBS. PER ACRE OR 2,2 LBS. PER 1,000 SO. FT.

(NOTE: THIS IS THE EQUIVALENT OF 500 LBS. PER ACRE OF 10-20-20 FERTILIZER OR 1,000 LBS. PER ACRE OF 5-10-10).

B. SEED SHOULD BE SPREAD UNIFORMLY BY THE METHOD MOST APPROPRIATE FOR THE SITE METHODS INCLUDE BROADCASTING, DRILLING, AND HYDROSEEDING WHERE BROADCASTING IS USED, COVER SEED WITH 25 INCH OF SOLIO OR LESS, BY CULTIFACKING OR RAWING.

•	SEEDI	NO	OU	DE:

	SEEDING		SOIL TYPE		
USE	MEXTURE (SEE 3D)	DROUGHTY	DRAINED	MOD, WELL DRAINED	POORLY DRAINED
STEEP CUTS AND FILLS, BORROW AND DISPOSAL AREAS	A B C	FAIR POOR FAIR	GOOD GOOD EXCELLENT	GOOD FAIR EXCELLENT	FAIR FAIR POOR
WATERWAYS, EMERGENCY SPILL- WAYS, AND OTHER CHANNELS WITH FLOWING WATER	A	GOOD	GOOD	GOOD	FAIR
LIGHTLY USED PARKING LOTS, ODD AREAS, UNUSED LANDS, AND LOW INTERNETTY LIGE DEPOSITION STITES	A B	GOOD GOOD	GOOD	GOOD FAIR	FAIR POOR

POUNDS | POUNDS PER

MDCTURE	PER ACRE	1,000 SQ. FT.
A TALL FESCUE	20	0.45
CREEPING RED FESCUE	20	0.45
REDTOP	2	0.05
TOTAL:	42	0.95
B TALL FESCUE	15	0.35
CREEPING RED FESCUE	10	0.25
CROWN VETCH OR	15 OR	0.35 OR
FLATPEA	30	0.75
TOTAL:	40 OR 55	0.95 OR 1.35
C TALL FESCUE	20	0.45
FLATPEA	30	0.75
TOTAL:	50	1.20

WHEN SEEDED AREAS ARE NOT MUICHED, PLANTINGS SHOULD BE MADE FROM EARLY SPRING TO MAY 20 OR FROM AUGUST 10 TO SEPTEMBER 1.

1. Territorial statements						
SPECIES	POUNDS PER ACRE	POUNDS PER 1,000 SQ. FT.				
WINTER RYE	112	2,5	BEST FOR FALL SEEDING, SEED FROM AUGUST TO SEPTEMBER 5TH FOR BEST COVER. SEED TO A DEPTH OF 1 INCH.			
OATS	80	2.0	BEST FOR SPRING SEEDING. SEED NO LATER THAN MAY 15TH FOR SUMMER PROTECTION. SEED TO A DEPTH OF 1 INCH.			
ANNUAL RYEGRASS	40	1,0	GROWS QUICKLY, BUT IS OF SHORT DURATION. USE WHERE APPEARANCES ARE NOT IMPORTANT. SEED EARLY SPRING AMOJOR BETWEEN AUGUST 15TH AND SEPTEMBER LISTH COVER SEED WITH NO MORE THAN 0.25 INCH OF SOIL.			
PERENNIAL RYEGRASS	30	0.7	GOOD COVER WHICH IS LONGER LASTING THAN ANNUAL RYSGRASS. SEED BETWEEN APRIL 1ST AND JUNE 1ST AND JONE BETWEEN AUGUST 1STH AND SEPTEMBER 1STH. MULCHING WILL ALLOW SEEDING THROUGHOUT THE GROWING SEASON, SEED TO A DEPTH OF APPROXIMATELY OS INCH.			


MULCH
 A. HAY, STRAW, OR OTHER MULCH, WHEN NEEDED, SHOULD BE APPLIED IMMEDIATELY AFTER SEEDING.

B. MULCH WILL BE HELD IN PLACE USING APPROPRIATE TECHNIQUES FROM THE BEST MANAGEMENT PRACTICE FOR MULCHING.

MAINTENANCE TO ESTABLISH A STAND
 A PLANTED AREAS SHOULD BE PROTECTED FROM DAMAGE BY FIRE, GRAZING, TRAFFIC, AND DENSE WEED
GROWTH.

B. FERTILIZATION NEEDS SHOULD BE DETERMINED BY ON SITE INSPECTIONS. SUPPLEMENTAL FERTILIZER IS USUALLY THE KEY TO PULLY COMPLETE THE ESTABLISHMENT OF THE STAND BECAUSE MOST PERENNIALS TAKE 2 TO 3 YEARS TO BECOME ESTABLISHED.

C. IN WATERWAYS, CHANNELS, OR SWALES WHERE UNIFORM R.OW CONDITIONS ARE ANTICIPATED, OCCASIONAL MOWING MAY BE NECESSARY TO CONTROL GROWTH OF WOODLY VEGETATION.

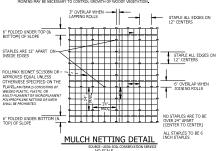

EROSION CONTROL GENERAL NOTES

A. KEEP SITE MODIFICATION TO A MINIMUM
 CONSIDER FITTING THE BUILDINGS AND STREETS TO THE NATURAL TOPOGRAPHY. THIS REDUCES THE NEED FOR CUTS AND FILLS. AVOID EXTENSIVE GRADING THAT WOULD ALTER PRAININGE PATTERNS OR CREATE VERY STEEP SLOPES.

2. EXPOSE AREAS OF BARE SOIL TO EROSIVE ELEMENTS FOR THE SHORTEST TIME POSSIBLE.

SAVE AND PROTECT DESIRABLE EXISTING VEGETATION WHERE POSSIBLE. ERECT BARRIERS
TO PREVENT DAMAGE FROM CONSTRUCTION EQUIPMENT.

5. AVOID SUBSTANTIAL INCREASE IN RUNOFF LEAVING THE SITE.

B. MINIMIZE POLLUTION OF WATER DURING CONSTRUCTION ACTIVITIES 1. STOCKPILE TOPSOIL REMOVED FROM CONSTRUCTION AREA AND SPREAD OVER ANY DISTURBED AREAS PRIOR TO REVEGETATION. TOPSOIL STOCKPILES MUST BE PROTECTED FROM BROSION.

- PROTECT BARE SOIL AREAS EXPOSED BY GRADING ACTIVITIES WITH TEMPORARY VEGETATION OR MULCHES.
- USE SEDIMENT BASINS TO TRAP DEBRIS AND SEDIMENT WHICH WILL PREVENT THESE MATERIALS FROM MOVING OFF SITE.
- USE DIVERSIONS TO DIRECT WATER AROUND THE CONSTRUCTION AREA AND AWAY FROM EROSION PRONE AREAS TO POINTS OF SAFE DISPOSAL.
- 5. USE TEMPORARY CULVERTS OR BRIDGES WHEN CROSSING STREAMS WITH EQUIPMENT.
- PLACE CONSTRUCTION FACILITIES, MATERIALS, AND EQUIPMENT STORAGE AND MAINTENANCE AREAS AWAY FROM DRAINAGE WAYS.

- C. PROTECT AREA AFTER CONSTRUCTION.

 1. ESTABLISH GRASS OR OTHER SUITABLE VEGETATION ON ALL DISTURBED AREAS. SELECT SPECIES ADAPTED TO THE SITE CONDITIONS AND THE FUTURE USE OF THE AREA. FINAL GRADES SHALL BE SEEDED WITHIN 72 HOURS. STABILIZATION SHALL BE DEFINED AS 85%
- MAINTAIN VEGETATED AREAS USING PROPER VEGETATIVE 'BEST MANAGEMENT PRACTICES' DURING THE CONSTRUCTION PERIOD.
- MAINTAIN NEEDED STRUCTURAL "BEST MANAGEMENT PRACTICES" AND REMOVE SEDIMENT FROM DETENTION PONDS AND SEDIMENT BASINS AS NEEDED.
- DETERMINE RESPONSIBILITY FOR LONG TERM MAINTENANCE OF PERMANENT 'BEST MANAGEMENT PRACTICES'. 5. IF CONSTRUCTION IS ANTICIPATED DURING WINTER MONTHS, REFER TO 'COLD WEATHER

SITE STABILIZATION REQUIREMENTS'.

D. INVASIVE SPECIES AND FIGURITY DUST

1. THE PROJECT SHALL NOT CONTRIBUTE TO THE SPREAD OF INVASIVE SPECIES, PRIOR TO
CONSTRUCTION, THE CONTROCTOR SHALL TAKE MICESSARY MEASURES TO REQUIT THEIR
INVASIVE SPECIES, AND IF FOUND SHALL TAKE INCESSARY MEASURES TO REQUIT THEIR
THE PRIOR OF THE PROJECT OF THE REPORT THE REPORT OF THE PROJECT OF A PRIOR TO THE PROJECT OF T

(14-1/2 GA, MIN., MAX, 6" MESH SPACING) WITH FILTER CLOTH OVER

SECTION VIEW

SEDIMENT FENCE

2. FUGITIVE DUST SHALL BE CONTROLLED IN ACCORDANCE WITH ENV-A 1000.

CONSTRUCTION NOTES FOR SEDIMENT FENCE

 FILTER CLOTH TO BE FASTENED SECURELY TO WOVEN WIRE FENCE WITH TIES SPACED EVERY 24" AT TOP, MID SECTION, AND BOTTOM. WHEN TWO SECTIONS OF FILTER CLOTH ADJOIN EACH OTHER, THEY SHALL BE OVERLAPPED BY 6 INCHES, FOLDED AND STAPLED.

MAINTENANCE SHALL BE PERFORMED AS NEEDED AND MATERIAL REMOVED WHEN "BULGES" DEVELOP IN THE SEDIMENT FENCE, OR 50% OF CAPACITY IS USED.

5. 12" DIAMETER FILTREXX SILTSOXX SHALL BE CONSIDERED AN ACCEPTABLE EQUAL TO SEDIMENT FENCE IF INSTALLED PER MANUFACTURER'S RECOMMENDATIONS.

COLD WEATHER SITE STABILIZATION REQUIREMENTS

TO ADEQUATELY PROTECT WATER QUALITY DURING COLD WEATHER AND DURING SPRING RUNOFF, THE FOLLOWING ADDITIONAL STABILIZATION TECHNIQUES SHALL BE EMPLOYED DURING THE PERIOD FROM OCTOBER 15 THROUGH MAY 1:

- THE AREA OF EXPOSED, UNSTABILIZED SOIL SHALL BE LIMITED TO 1 ACRE AND SHALL BE PROTECTED AGAINST EROSION BY THE METHODS DESCRIBED IN THIS SECTION PRIOR TO ANY THAW OR SPRING MELT EVENT THE ALLOWABLE AREA OF EXPOSED SOIL MAY BE INCREASED IF A WINTER CONSTRUCTION FLAW, DEVELOPED BY A QUALIFIED ENGINEER OR A CPESC SPECIALIST. IS REVIEWED AND APPROVED BY NHDES.
- 2. ALL PROPOSED VEGETATED AREAS HAVING A SLOPE OF LESS THAN 15% WHICH DO NOT EXHIBIT A MINIMUM OF 85% VEGETATIVE GROWTH BY OCTOBER 15, OR WHICH ARE DISTURBED AFFER OCTOBER 15, SHALL BE SEEDED AND COVERED WITH 3 TO 4 TONS OF HAY OR STRAW MULCH PER ACRE, SECURED WITH ANCHORED NETTING OR TACKIFIER, OR 2 INCHES OF EROSION CONTROL MIX MEETING THE CRITERIA OF ENV-WQ 1506.05(D) THROUGH (H)
- 3. ALL PROPOSED VEGETATED AREAS HAVING A SLOPE OF GREATER THAN 15% ALL PREVISED YESSER ALLD MICHS HAVING A SLUDE OF GREATER IN HIM 15% WHICH DO NOT SHEBIT A MINIMUM OF 95% VEGETATIVE GROWTH BY OCTOBER 15, OR WHICH ARE DISTURBED AFTER OCTOBER 15, HALL SEEDED AND COVERED WITH PROPERLY INSTALLED AND ANA-ORDE EROSION CONTROL MIX METHOD OR WITH A MINIMUM A HICH TRICKIESS OF EROSION CONTROL MIX MEETING THE CULTERA OF ENWAYQ 150C(6)(1) THROUGH (H)
- THE CRITERIA OF ENV-WQ 1506.05(D) THROUGH (H), SHALL NOT OCCUR OVER SNOW OF GREATER THAN 1 INCH IN DEPTH.
- 5. INSTALLATION OF EROSION CONTROL MATTING SHALL NOT OCCUR OVER SNOW OF GREATER THAN ONE INCH IN DEPTH OR ON FROZEN GROUND.

 STATEMAN OF THE S
- ALL PROPOSED STABILIZATION IN ACCORDANCE WITH NOTES 2 OR 3 ABOVE SHALL BE COMPLETED WITHIN 1 DAY OF ESTABLISHING THE GRADE THAT IS FINAL OR THAT OTHERWISE WILL EXIST FOR MORE THAN 5 DAYS.
- ALL DITCHES OR SWALES WHICH DO NOT EVHIBIT A MINIMUM OF 85% VECETATIVE GROWTH BY OCTOBER 15, OR WHICH ARE DISTURBED AFTER OCTOBER 15, SHALL BE STABLIZED TEMPORABLY WITH STONE OR REOSION CONTROL BLANKETS APPROPRIATE FOR THE DESIGN FLOW CONDITIONS, AS DETERMINED BY THE CONNECS REOSINEENING CONSULTANT.
- 8. AFTER OCTOBER 15, INCOMPLETE ROAD OR PARKING AREAS WHERE ACTIVE CONSTRUCTION OF THE ROAD OR NORKING AREA HAS STOPPED FOR THE WINTER SEASON SHALL BE PROTECTED WITH A MINIMUM 3 INCH LAYER OF BASE COURSE GRAVELS MEETING THE GRADATION REQUIREMENTS OF INDIOT STANDARD SPECIFICATION FOR ROAD AND BRIDGE CONSTRUCTION, 2016, ITEM

NOTES

1. CONSTRUCT BOOK CHECK DAMS WHERE INDICATED ON THE PLANS OF AS NECESSARY. 2. CONSTRUCT SPILL WAY IN CENTER OF ROCK CHECK DAM 6" RELOW TOP OF CHANNEL. THE MAXINUM SPACING BETWEEN THE CHECK DAMS SHOULD BE SUCH THAT THE TOE
OF THE UPSTREAM CHECK DAM IS AT THE SAME BLEVATION AS THE SPILLWAY
BLEVATION OF THE DOWNSTREAM CHECK DAM!, THIS WILL VARY DEPENDING ON THE
SLOPE OF THE CHAMBEL.

4. ROCK CHECK DANS SHALL CONSIST OF A WELL GRADED MIXTURE OF 2" - 3" STONE.

REMOVE ROCK CHECK DAMS AND ANY ACCUMULATED SILT IN CHANNEL ONCE PERMANENT CHANNEL LININGS HAVE BEEN ESTABLISHED AND STABILIZED.

LEVEL LIP SPREADER INSTALLATION

- CONSTRUCT THE LEVEL SPREADER LIP ON A ZERO PERCENT GRADE TO INSURE UNIFORM SPREADING OF RUNOFF.
- 2. LEVEL SPREADER SHALL BE CONSTRUCTED ON UNDISTURBED SOIL AND NOT ON
- AN EROSION STOP SHALL BE PLACED VERTICALLY A MINIMUM OF SIX INCHES DEEP IN A SLIT TRENCH ONE FOOT BACK OF THE LEVEL LIP AND PARALLEL TO THE LIP. THE EROSION STOP SHALL EXTEND THE ERVIRSE LENGTH OF THE LEVEL LIP.
- THE ENTIRE LEVEL LIP AREA SHALL BE PROTECTED BY PLACING TWO STRIPS OF JUTE OR EXCELSIOR MATTING ALONG THE LIP. EACH STRIP SHALL OVERLAP THE EROSION STOP BY AT LEAST SIX INCHES.
- THE ENTRANCE CHANNEL TO THE LEVEL SPREADER SHALL NOT EXCED A 1 PERCENT GRADE FOR AT LEAST 50 FEET BEFORE ENTERING INTO THE SPREADER.
- THE FLOW FROM THE LEVEL SPREADER SHALL OUTLET ONTO STABILIZED AREAS. WATER SHOULD NOT RE-CONCENTRATE IMMEDIATELY BELOW THE SPREADER.
- 7. PERIODIC INSPECTION AND REQUIRED MAINTENANCE SHALL BE PERFORMED.
- 8. PROTECTIVE MATERIAL AND EROSION STOP SHALL BE NORTH AMERICAN GREEN C125 EROSION CONTROL BLANKET OR APPROVED EQUAL.

4. INSTALLATION OF ANCHORED HAY MULCH OR EROSION CONTROL MIX, MEETING SECOND STRIP OF PROTECTIVE MATERIAL EXISTING GRADE

LEVEL SPREADER DETAIL

NO SCALE SOURCE: ROCKINGHAM COUNTY CONSERVATION SERVICE


CONSTRUCTION SEQUENCE

- PREPARE AN EROSION CONTROL PLAN OR A STORMWATER POLLUTION PREVENTION PLAN (SWPPP) IN ACCORDANCE WITH LOCAL, STATE, AND FEDERAL REQUIREMENTS.
- 2. INSTALL CONSTRUCTION ENTRANCE, SEE DETAIL.
- 3. CUT AND CLEAR TREES WITHIN THE CLEARING LIMITS.
- 4. INSTALL SEDIMENT FENCES, ROCK CHECK DAMS, AND OTHER APPROPRIATE EROSION CONTROL MEASURES AT LOCATIONS SHOWN ON THE PLANS AND AS NEEDED.
- 5. GRUB SITE WITHIN GRADING LIMITS.
- 6. STRIP AND STOCKPILE TOPSOIL AND INSTALL EROSION CONTROL MEASURES.
- 7. INSTALL/ADJUST SEDIMENT FENCE, CHECK DAMS, AND HAYBALES, AS
- CONSTRUCT PERMANENT STORMWATER CONTROLS AS SOON AS PRACTICAL
 DO NOT DIRECT STORMWATER TOWARD TREATMENT BASINS, PONDS, SWALES
 DITCHES AND LEVEL SPREADERS UNTIL THEY HAVE BEEN STABILIZED.
- PROCEED WITH WORK, LIMITING THE DURATION OF DISTURBANCE. THE MAXIMUM OF UNCOVERED DISTURBED EARTH AT ANY ONE TIME IS FIVE ACRES. THE MAXIMUM LEWISTH OF TIME THAT DISTURBED EARTH MAY BE LEFT UNSTABILIZED IS 45 DAYS.
- BEGIN SEEDING AND MULCHING IMMEDIATELY AFTER GRADING. ALL DISTURBED AREAS SHALL BE STABILIZED WITH APPROVED METHODS WITHIN 72 HOURS OF ACHIEVING FINISHED GRADE.


IN AREA SHALL BE CONSIDERED STABLE IF ONE OF THE FOLLOWING HAS OCCURRED:

A) BASE COURSE GRAVELS HAVE BEEN INSTALLED IN AREAS TO BE PAMED;
B) AM KINMUM OF 85% VECETATED GROWTH HAS BEEN ESTABLISHED;
C) AM MINIMUM OF 30° OF MONE-ROSIVE MATERIALS, SUCH AS STONE OR
RIJERAP HAS BEEN INSTALLED; OR
D) EROSION CONTROL EXAMESTE HAVE BEEN PROPERLY INSTALLED.

- INSPECT ALL EROSION CONTROL MEASURES ON A DAILY BASIS AND AFTER EVERY 0.5 INCHES OF PRECIPITATION. MAINTAIN SEDIMENT FENCE, SEDIMENT TRAPS, HAY BALES, ETC., AS NECESSARY.
- 13. PLACE TOPSOIL, SEED AND MULCH.
- 14. COMPLETE ALL REMAINING PERMANENT EROSION CONTROL STRUCTURES.
- MONITOR THE SITE AND MAINTAIN STRUCTURES AS NEEDED UNTIL FULL VEGETATION IS ESTABLISHED.

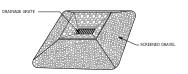

PERSPECTIVE VIEW

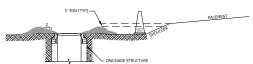

SECTION


MATERIALS SPECIFICATIONS

- CONSTRUCTION SPECIFICATIONS:

 1. INSTALL GRAVEL INLET PROTECTION WHERE INDICATED OR WARRANTED.

 2. FOR ALL INSTALLATIONS WHERE INLET PROTECTION IS WITHIN 8 OF EDGE OF PAVEMENT, A ROADWAY COME SHALL BE USED BETWEEN CATCH BASIN AND SHOULDER.
- 3 ENSURE CREST OF GRAVEL PLACED AROUND CATCH BASI IS AT LEAST 3" BELOW ELEVATION OF EDGE OF PAVEMENT.

CATCH BASIN INLET PROTECTION DETAIL

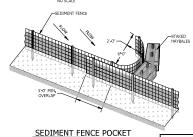

PROGRESS PRINT NOT FOR CONSTRUCTION

horizans

176 Newport Road, Suite 8; New London NH 03255 (603) 877-0116

NH STATE PARKS

Campground Expansion Project PI Mollidgewock State Park 1437 Berlin Road Berlin, NH

30% DESIGN

Scale: N/A Date: August 25, 2023


Drawn By: DW

EROSION CONTROL **DETAILS**

C3.00

Project Number: 23045001 File: 220838 - x-site.dwg

ROCK CHECK DAM DETAIL NO SCALE

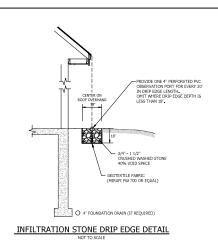

Topic Land Survey of the Market NEW HAPPSHEE - VERNORT

176 Newport Road, Suite 8; New London NH 03255 (663) 877-0116 www.horizonsengineering.com

NH STATE PARKS

Campground Expansion Project Pli Mollidgewock State Park 1437 Berlin Road Berlin, NH 03579

30% DESIGN

Scale: N/A

Date: August 25, 2023

Drawn By: DW


	Issues:						
ı	No.	Description	Date				
ı	1	Name	00/00/00				
ı							
ı							
ı							
ı							
ı							
ı							

CIVIL DETAILS

C3.10

PROGRESS PRINT NOT FOR CONSTRUCTION

Project Number: 23045001 File: 220838 - x-site.dwg

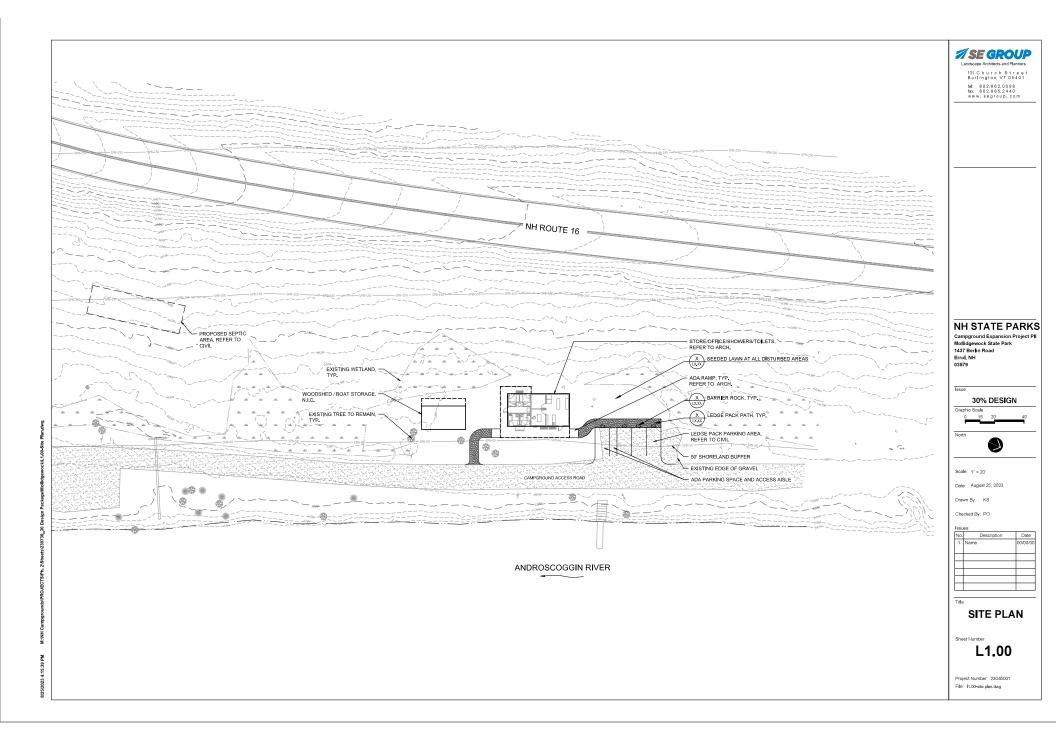

- NT STATE BUILDING CODE NSA 155-A INTERNATIONAL BUILDING CODE (IBC) 2018 EDITION, AS AMENDED
- NEW HAWPSHIRE SAS-C 6000 FIRE CODE HEFA I FRE CODE 2018 EDITION NEFA 101 LIPE SAFETY CODE 2018 EDITION CHAPTER 36, "NEW MEXCAPILLE."
- INTERNATIONAL ENERGY CONSERVATION CODE (IECC) 2018 EDITION

 ** INTERNATIONAL PLUMENUS CODE (IPC) 2018 EDITION

 ** INTERNATIONAL INCLINICAL CODE (IMC) 2018 EDITION

 ** INTERNATIONAL INCLINICAL CODE (IMC) 2020

 ** INTERNATIONAL INCLINICAL CODE (IMC) 2020
- ~ APPLICABLE ACCESSIBILITY CODES & STANDARDS:
 ICC AT 17, 1-2003 ACCESSIBLE & USABLE BUILDINGS & PACILITIES

PROPOSED FACILITY:

- ~ OVERALL PACILITY FIRE PROTECTION
- ~ OCCUPANCY CLASSIFICATION: IBC BUSINESS (B); LSC CHAPTER 38, "NEW PLANNING REQUIREMENTS:
- ~ CONSTRUCTION CLASSIFICATION: TYPE VB (COMBUSTIBLE, NO RATING)
- ~ BUILDING STORIES & HEIGHT (IBC TABLES 504.3 & 504.4)
- ALLOWABLE STORIES: 2 STORIES PROPOSED STORIES: 1 STORY = (20MPL/ES
- ALLOWABLE HEIGHT: 407-0" (TO AVERAGE HEIGHT OF HIGHEST ROOF PLANE) PROPOSED HEIGHT: $15.0^\circ = \underline{\text{COMPLMS}}$
- ~ BUILDING AREA (IBC TABLE 506.2)
- ALLOWABLE AREA (18T FLOOR PLAN): 9,000 GBF CONFIRMS
- TOTAL PROPOSED GROSS FLOOR AREAS: 1,585 SF

CODE SUMMARY

FIRE RESISTANCE RATINGS REQUIREMENTS:

- MAXIMUM TRAVEL DISTANCE: 200 FEET (38.2.6.3)
- MAXIMUM DEAD-END CORRIDOR LENGTH: 20 FEET (38.2.5.2)
- MAXIMUM COMMON FAITH OF TRAVEL: 75 FEET (38.2.5.3.1)
- INTERIOR FINISH, FLOORS: NO REQUIREMENTS (38.3.3.3)
- INTERIOR FINISH, VALLS AND CELING: A, B, or C (38.3.3)

ENERGY CODE - MINIMUM THERMAL ENVELOPE REQUIREMENTS:

- ACCESSIBLE TOLLET ROOMS: ALL NEW TOLLET 4 SHOWER ROOMS ARE REQUIRED TO BE ACCESSIBLE (IBC CHAPTER LT). MH AVEHORBITI SINGLE OCCUPANCY TOLLETS MAY BE UNSEN PROVIDED THE NUMBER OF WATER CLOSETS COMPLIES WITH TABLE 2902.1.

Storage SALES Store Office 0 Únisek Unisex 924 sq. ft, enclosed building area 661 sq. ft. covered porch 1,585 sq. ft. total building area Covered Porch

SAMYN - D'ELIA ARCHITECTS, P.A.

P.O. Box 229 Holderness, NH 03245 tel: (603) 968-7133

HVAC, Elec. & Plumb, Engineer: Charles P. Buckley, P.E. 500 Depot Street Rumney, NH 03266 tel: (603) 786-9992

Structural Engineer: Fisher Engineering, P.C. 686 Belknap Mountain Road Gilford, NH 03249 tel: (603) 528-7641

NH STATE PARKS

Campground Expansion Project PII Mollidgewock State Park 1437 Berlin Road Errol, NH 03579

30% DESIGN

Teerse

North

Scale: As indicated

Date: Aug. 25, 2023

Drawn By: MR Checked By: WD

Issues:				
No.	Description	Date		

MAIN FLOOR PLAN

Sheet Number

A1.01

MAIN FLOOR PLAN 1/4"=1'-0"
Scale: 1/4" = 1'-0"

HVAC, Elec. & Plumb. Engineer: Charles P. Buckley, P.E. 500 Depot Street Rumney, NH 03266 tel: (603) 786-9992


Structural Engineer: Fisher Engineering, P.C. 686 Belknap Mountain Road Gilford, NH 03249 tel: (603) 528-7641

NH STATE PARKS

Campground Expansion Project PII Mollidgewock State Park 1437 Berlin Road Errol, NH 03579

No.	Description	Dat

A1.02

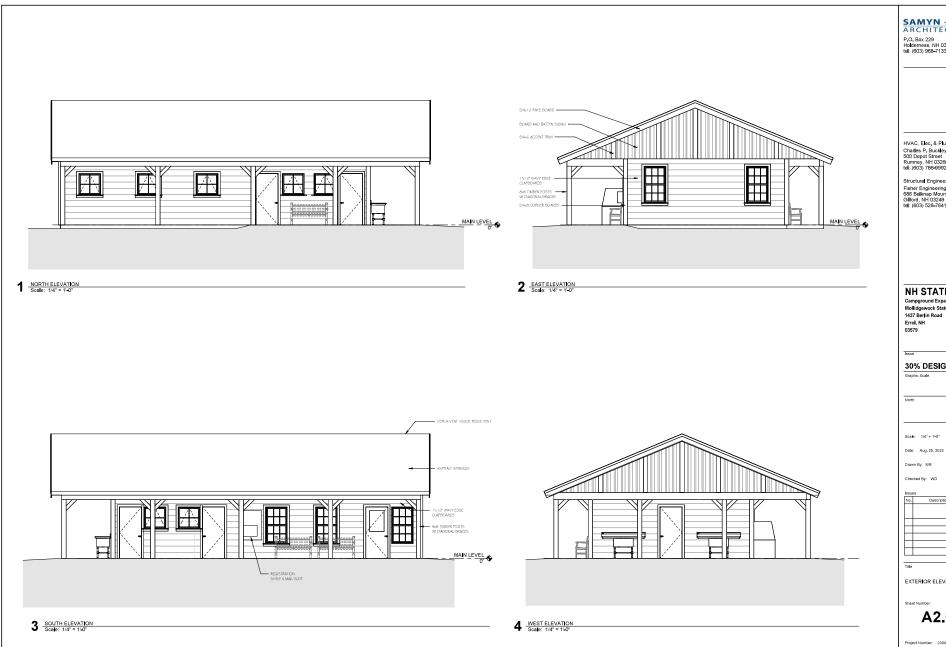

SAMYN - D'ELIA ARCHITECTS, P.A.

P.O. Box 229 Holderness, NH 03245 tel: (603) 968-7133

HVAC, Elec. & Plumb, Engineer: Charles P. Buckley, P.E. 500 Depot Street Rumney, NH 03266 tel: (603) 786-9992

Structural Engineer: Fisher Engineering, P.C. 686 Belknap Mountain Road Gilford, NH 03249 tel: (603) 528-7641

NH STATE PARKS

Campground Expansion Project PII Mollidgewock State Park 1437 Berlin Road Errol, NH 03579

30% DESIGN


Scale: 1/4" = 1'-0"


Issues:				
No.	Description	Date		
Г				
Г				
Г				

EXTERIOR ELEVATIONS

Sheet Number:

A2.01

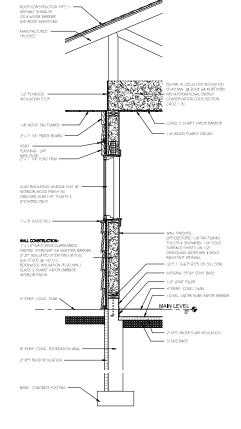

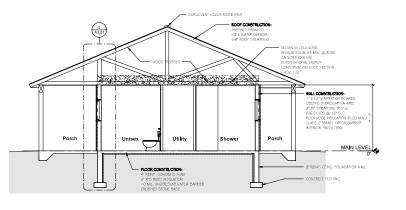

BUILDING SECTION
Scale: 1/4" = 1'-0"

SAMYN - D'ELIA ARCHITECTS, P.A.

P.O. Box 229 Holderness, NH 03245 tel: (603) 968-7133

HVAC, Elec. & Plumb. Engineer: Charles P. Buckley, P.E. 500 Depot Street Rumney, NH 03266 tel: (603) 786-9992

Structural Engineer: Fisher Engineering, P.C. 686 Belknap Mountain Road Gilford, NH 03249 tel: (603) 528-7641

NH STATE PARKS

Campground Expansion Project PII Mollidgewock State Park 1437 Berlin Road Errol, NH 03579

sue

30% DESIGN

Grapnic Scale

Scale: As indicated

Date: Aug. 25, 2023

Drawn By: MR
Checked By: WD

su	95:	
lo.	Description	Date
_		

Title

BUILDING & WALL SECTIONS

Sheet Number:

A3.01

oject Number: 23045001

2 WALL SECTION
Scale: 3/4" = 1-0"

SWillelDocuments/Wollidgewock Office Store Bathhouse Arch

HVAC NOTES

SCOPE OF WORK

- A THE CONTRACTOR IS RESPONSIBLE FOR ALL WORK, MATERIALS, AND LABOR TO SATISFY A COMPLETE WORKING SYSTEM WHETHER SPECIFIED OR IMPLIED.
- B. ALL YORK IS TO BE PERFORMED IN STRICT COMPLIANCE WITH THE INTERNATIONAL MECHANICAL CODE 2018, ALL LOCAL AND ALL DITHER REGULATION GOVERNING WORK OF THIS NATURE.
- C. THE CONTRACTOR SHALL, BEFORE SUBMITTING ANY PROPOSAL, EXAMINE THE PROPOSED SITE AND SHALL DETERMINE FOR HIMSELF THE CONDITIONS THAT MAY EFFECT THE VOKK, NO ALLOVANCE SHALL BE MADE IF THE CONTRACTOR FAILS TO MARE SLICH EXAMINATIONS.
- D. ALL EQUIPMENT AND MATERIALS SHALL BE AS SPECIFIED OR "APPROVED EQUAL" BY THE ENGINEER OR ARCHITECT.

2. PERMITS

A. THE CONTRACTOR SHALL SECURE ALL PERMITS OR APPLICATIONS AND PAY ANY AND ALL FEES.

3. SHIP DRAWINGS

A SUBMIT MATERIAL LIST AND SHOP DRAWINGS FOR MAJOR EQUIPMENT TO THE ACHITECT/ENGINEER FOR APPROVAL. THE CONTRACTOR SHALL SUBMIT FIVE SETS OF SHOP DRAWINGS AND THEY SHALL BE CLEARLY LABELED.

4. BUCTVERK

- A THE DUCTYORK SHALL BE CONSTRUCTED IN ACCORDANCE WITH THE 'SMACNA' APPLICABLE MANUALS, ALL DUCTWORK SHALL BE THE LOW VELOCITY TYPE, UNLESS SPECIFIED OTHERWISE.
- B CONTRACTOR SHALL PROVIDE AND INSTALL APPROVED FIRE DAMPERS AND ACCESS PANELS IN ANY AND ALL DUCTVERK WHICH PENETARIES A HORIZIONTAL OR VERTICAL FIRE PARTI-TION, OR AS OTHERWISE SHOWN ON DRAWINGS.
- C. ALL BRANCH DUCTS TO HAVE VOLUME DAMPERS.
- D. SMOOTH TURN RADIUS DUCTWORK OR TURNING WANES SHALL BE USED THROUGHOUT WHERE FLOW EXCEEDS 150 CFM.
- E. ALL DUCT JOINTS TO BE SEALED IN ACCORDANCE WITH "SMACNA" STANDARDS AND ACCEPTED GOOD PRACTICE.
- F. ALL DUCT DIMENSIONS SHOWN ARE NET INSIDE VALUES.

 DIMENSIONS MAY BE CHANGED SO LONG AS THE NET FREE
 FACE AREA IS MAINTAINED.

5. HVAC CONTROLS

A CONTRACTOR TO SUPPLY AND INSTALL ALL CONTROL WIRING AND THERMOSTATS AS REQUIRED.

ELECTRIC

A CONTRACTOR TO COURDINATE WITH ELECTRICAL CONTRACTOR FOR LOCATION OF WIRING FOR EACH HVAC UNIT.

7. MISCELLANEOUS


- A. ALL EXTERIOR OPENINGS TO BE PROPERLY CAULKED AND SEALED WITH A SEALANT OF HIGH QUALITY AND LONG LIFE, TO PREVENT INFILTRATION OF DUTSIDE AIR INTO CONDITIONED SPACE.
- B. DO NOT SCALE THIS DRAWING FOR EXACT DIMENSIONS. VERIFY ALL FIGURES, CONDITIONS, AND DIMENSIONS AT THE JUB SITE.
- C. THE MECHANICAL PLANS ARE INTENDED TO BE DIAGRAMMATIC AND ARE BAKED BY DIR MANIFACTURE'S EQUIPMENT. THE ARE NOT INTENDED TO SIGN EVERY TIPMENT. THE AREA OF THE EQUIPMENT, THE CONTRACTOR SHALL VERIFY THE ACTUAL DIMENSIONS OF THE COUPMENT PROPOSED TO EXSURE THAT THE EQUIPMENT WILL FOR THE COUPMENT PROPOSED TO THE OWNER THAT THE EQUIPMENT WILL FIT IN THE AVAILABLE SPACE.


8. TESTING AND BALANCING

A. THE HVAC SYSTEM SHALL BE TESTED AND AND BALANCED BY AN INDEPENDENT ACENCY, UNDER THE SUPER-VISION OF A LICENSED PROFESSIONAL ENGINEER. A SEALED TYPE WRITTEN REPORT SHALL BE SUBMITTED TO THE ARCHITECT/ENGINEER FOR REVI

9. GUARANTEE

- A MATERIALS, EQUIPMENT AND INSTALLATION SHALL BE GUARANTEED FOR A PERIOD OF DIMEOUYEAR FROM DATE OF ACCEPTANCE DEFECTS WHICH APPEAR DURING THAT PERIOD SHALL BE CORRECTED AT THIS CONTRACTOR'S EXPENSE.
- B.FOR THE SAME PERIOD, THE MECHANICAL CONTRACTOR SHALL BE RESPONSIBLE FOR ANY DAMAGE TO PREMISES CAUSED BY DEFECTS IN WURKHANSHIP OR IN THE WORK OR EQUIPMENT FURNISHED AND/OR INSTALLED BY HIM.

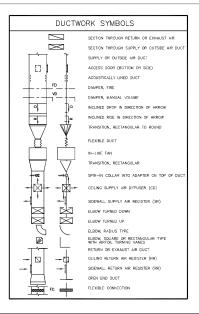

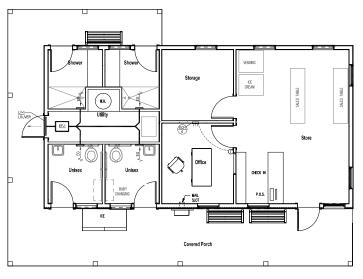

MECHANICAL PLAN

					FAN S	CHEDL	JLE		
MAR	RK	SERVICE	LOCATION	CFM	STATIC PRESS.	MOTOR			MANUFACTURE & MODEL
					(IN. W.G.)	HP	RPM	VOLT-PHASE	
EF-	-1	TOILETS RMSHOWERS	CHASE	200	0.625	1/6	1800	115-1	GREENHECK SQ-80-VG

	ELECTRIC CABINET HEATER SCHEDULE								
EQUIPMENT NO.	VOLTS/PHASE	AMPS	KW	BTU HR.	MANUFACTURER & MODEL	OPTIONS-ACCESSORIES			
ECH-1	120/1	12,5	1.5	5120	QMARK MODEL AWH3150F	RECESSED MOUNTING BOX LINE VOLTAGE WALL MOUNT THERMOSTAT			
NOTES:						·			

CHARLES P. BUCKLEY PROFESSIONAL ENGINEER PROFESSIONAL ENGINEER REMARK, M.E. TRL (603)766-5962 TRL (603)766-2965

N.H. LIC. NO. 09198

HVAC, Elec. & Plumb. Engineer: Charles P. Buckley, P.E. 500 Depot Street Rumney, NH 03266 tel: (603) 786-9992

Structural Engineer: Fisher Engineering, P.C. 686 Belknap Mountain Road Gifford, NH 03249 tel: (603) 528-7641

NH STATE PARKS

Campground Expansion Project PII Mollidgewock State Park 1437 Berlin Road Errol, NH 03570

Issue

North

30% DESIGN

Graphic Scale

Scale: As indicated

Date: Aug. 25, 2023

Drawn By: CPB

Checked By; CPB

ssues;							
No.	Description	Date					
\top							
\neg							
Т							
Т							

Title

MECHANICAL PLAN AND DETAILS

Sheet Number:

M1.01M

Project Number: 23045001

File:

ELECTRICAL NOTES

- A. CONTRACTOR SHALL VISIT SITE PRIOR TO BIDDING, BIDS SHALL SERVE AS EVIDENCE OF KNOWLEDGE OF EXISTING CONDITIONS, FIELD VERIFY ALL ELECTRICAL EQUIPMENT.
- B. FURNISH ALL LABOR, MATERIALS, EQUIPMENT AND TOOLS TO PERFORM ELECTRICAL WORK SHOWN, NOTED OR SCHEDULED FOR A COMPLETE AND FINISHED INSTALLATION.
- MATERIALS, PRODUCTS AND EQUIPMENT, INCLUDING ALL COMPONENTS THEREOF, SHALL BE NEW AND SUCH AS APPEAR ON THE UNDERWRITERS LABORATORES UST OF APPROVED TERMS AND SHALL BE SZED IN CONTOMINTY WITH DECUMENDATIS OF THE NATIONAL ELECTRICAL CODE AND OTHER APPLICABLE CODES, WHICHEVER ARE MORE STRINGENT.
- C. ALL WORK TO BE IN ACCORDANCE WITH 2020 NEC AND ALL APPLICABLE FEDERAL, STATE

2. PERMITS:

A. SECURE AND PAY FOR ALL REQUIRED PERMITS AND INSPECTION CERTIFICATES.

3. SHOP DRAWINGS:

SUBMIT MATERIAL LIST AND SHOP DRAWNGS FOR MAJOR EQUIPMENT TO THE ARCHITECT FOR APPROVAL. SUBMIT MATERIAL DRAWNGS FOR MAJOR EQUIPMENT TO THE ARCHITECT FOR APPROVAL SUBMITTALS SHALL BE IN ACCORDANCE WITH CENTRAL CONTRION SHOWING THAT HE HAS REVERED AND APPROVAL WILL BE CAUSE FOR RECEITON WITHOUT REVEWE BY THE ARCHITECT OR PROPINCIP.

4. CONDUITS:

A. THE TYPE OF CONDUIT SHALL BE AS FOLLOWS FOR ALL FEEDERS AND DISTRIBUTION CIRCUITS, UNLESS OTHERWISE SPECIFIED.

APPLICATION	TYPE OF CONDUIT
OUTDOORS	GALV. RIGID STEEL OR EMT W/ W.P. FITTINGS
BRANCH CIRCUITS (EXPOSED)	EMT
BRANCH CIRCUITS (CONCEALED)	MC
SUPPLY TO DISTRIBUTION PANEL	EMT
UNDERGROUND SERVICE ENTRANCE	PVC - SCHEDULE 40

5. WRE:

- A. WIRE SHALL BE SINGLE CONDUCTOR COPPER WITH 600 VOLT INSULATION. MINIMUM WIRE SIZE SHALL BE \$12 EXCEPT \$14 MAY BE USED FOR CONTROL. ALL WIRE AND CABLE SHALL BE NEW AND SHALL BE GROUGHT TO THE SIZE IN UNBROKKEN PACKAGES.
 - . GENERAL WIRING SHALL BE THW OR THHN (ALUMINUM CONDUCTORS ARE NOT PERMITTED)
- B. WRE CONNECTORS SHALL BE EQUAL BY SCOTCHLOCK FOR #6 AND SMALLER AND T & B "LOCK-LITE" FOR #6 AND LARGER.

6. LIGHTING:

A, LIGHTING FIXTURES AND LAMPS (UNLESS NOTED OTHERWISE) SHALL BE FURNISHED BY THE ELECTRICAL CONTRACTOR, ELECTRICAL CONTRACTOR SHALL INSTALL ALL FIXTURES AND LAMPS.

- A. RECEPTACLES SHALL BE 20 AMP, 3-WIRE GROUNDING TYPE EQUAL TO HUBBELL 5362 (MOUNTING @ 18"A.F.F.).
- B. SWITCHES SHALL BE STANDARD GRADE RATED 20 AMP AT 120 VOLT (MOUNTING @48"A.F.F.)

8. SAFETY SWITCHES:

A. PROVIDE SAFETY AND DISCONNECT SWITCHES, FUSED OR NONFUSED, AS CALLED FOR ON DRAWINGS AND AS REQUIRED BY CODE. SWITCHES SHALL BE HEAVY DUTY, LOAD AND HOSSEPOWER RATED AS MANUFACTURED BY SOURCE D, 500 LD, TEC REQUIR.

- OUTLET BOXES AND COVERS SHALL BE GALVANIZED, ONE-PIECE PRESSED STEEL KNOCKOUT.

10. INSTALLATION:

- INSTALLATION.

 A ALL ELECTRICAL WORK SHALL BE INSTALLED SO AS TO BE READILY ACCESSIBLE FOR A ALL ELECTRICAL WORK SHALL BE INSTALLED SO AS TO BE READILY ACCESSIBLE FOR MADE RESOLUTION. THE RESOLUTION OF WORK AND SHALL BE FASTINATED TO STEEL CONCRETE OR WOOD, BUT NOT TO PHYOR, ALL CONDUCT SHALL BE CONCRALED WHEREVER POSSIBLE, WHICH WAS ALL CONDUCT SHALL BE CONCRALED WHEREVER POSSIBLE WITHOUT SHALL BE CONCRALED WHEREVER POSSIBLE WHICH SHALL BE CONCRALED WHEREVER POSSIBLE WHICH SHALL BE CONCRALED WHERE WHERE HE WAS ALL CONDUCT SHALL BE ASSOCIATED AND SHARL BE AND SHALL BE CONCRADED WHERE WHERE HE PER WAS ALL BE CONCRADED WHERE WHERE WE WAS ALL BE CONCRADED BY THE PER WAS ALL BY THE PER
- COMMUNI, DUCTS DR APPROVED RACEWAYS.

 FE CONTRACTOR SHALL DO ALL CUTTING, CHASING OR CHANNELING AND PATCHING REQUIRED FOR ANY MORY, UMDER THIS DIVISION, SILETYES SHALL EXTEN AT LEAST TIME (27) NOLES ABOVE PRINCIPLE FOR AND ALL SERVES, OPPRINGS, TEXT, PROCUEL PRIC NATED WALLS AND FLOORS SHALL BE SEARLD AFTER CONDUIT INSTALLATION TO REVENUE TO THE CONTRACT OF THE CO
- NEAMAN HELR YIER KAINN.

 C. THE FOLLOWING EQUIPMENT SHALL BE IDENTIFIED WITH ENGRAYED BAKELITE NAMEPLATES AS TO NAME AND/OR FUNCTION, DISTRIBUTION PANELS AND DISCONNECT SWITCHES.

 D. THE LOCATION OF COULTES AND EQUIPMENT SHOWN ON THE DRAWNINGS ARE APPROXIMATE AND THE ARCHITECT SHALL HAVE THE RIGHT TO RELOCATE ANY OUTLETS OR FIXTURES BEFORE THEY ARE INSTALLED WITHOUT ADDITIONAL COST...
- E. ELECTRICAL CONTRACTOR SHALL RECORD ALL FIELD CHANGES IN HIS WORK AS THE JOB PROGRESSES.

- A. MATERIALS, EQUIPMENT AND INSTALLATION SHALL BE GUARANTEED FOR A PERIOD OF ONE (1) YEAR FROM DATE OF ACCEPTANCE. DEFECTS WHICH APPEAR DURING THAT PERIOD SHALL BE CORRECTED AT THIS CONTRACTOR'S EXPENSE.
- B, FOR THE SAME PERIOD, THE ELECTRICAL CONTRACTOR SHALL BE RESPONSIBLE FOR ANY DAMAGE TO PREMISES CAUSED BY DEFECTS IN WORKMANISHIP OR IN THE WORK OR EQUIPMENT FURNISHED AND/OR INSTALLED BY HIM.

12. FINALLY:

A. IT IS THE INTENT THAT THE FOREGOING WORK SHALL BE COMPLETE IN EVERY RESPECT AND THAT ANY MATERIAL OR WORK NOT SPECIFICALLY MENTIONED OR SHOWN ON THE DRAWINGS, BUT NECESSARY TO FULLY COMPLETE THE WORK SHALL BE FURNISHED.

ELECTRICAL SYMBOLS

ABBREVIATIONS

REDITE VIA HONS

ABOVE COUNTE
ABOVE THISTED FLOOR
CREAT FREADER
EXPLOSION PROOF.
EXPLOSION NIGHT LIGHT PHOTOELECTRIC SWITCH POWER PANEL. RECEPTACLE PANEL. UNDERGROUND UNIESS OTHERWISE NOTED. WEATHER PROOF.

WIRING



WIRING CONCEALED IN CEILING OR WALLS; SLASH MARKS INDICATE NUMBER OF CONDUCTORS EXCLUDING GROUNDS; CONDUCTOR SIZE AS MARKED; #12 AWG UON.

UNDERGROUND CABLE OR DUCT; TYPE, SIZE, CONDUCTORS, AND ARRANGEMENT BY NOTATION OR SCHEDULE.

WIRING RUN EXPOSED.

SWITCHES


SWITCH OUTLET; MOUNTED 48" AFF UON; SINGLE POLE UON; LOWER CASE LETTER, WHEN PRESENT, INDICATES OUTLETS CONTROLLED.

- * ABBREVIATIONS FOR SWITCH OUTLETS
- DOUBLE POLE SWITCH 4-WAY SWITCH KEY OPERATED SWITCH DOOR SWITCH

- D DIMMER SWITCH; MOUNTED 48" AFF UON; LOWER CASE LETTER, WHEN PRESENT, INDICATES QUILLETS CONTROLLED.

LIGHTING

FLUORESCENT LIGHT FIXTURE - RECESSED, SURFACE, OR PENDENT MOUNTED 0

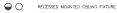



SURFACE OR PENDANT MOUNT EXIT SIGN FIXTURE; ARROWS $\overline{\Theta}$ INDICATE REQUIRED SIGN ARROWS.

BATTERY POWERED EMERGENCY LIGHTING FIXTURE Z-V COMBINATION EMERCENCY LICHTING FIXTURE AND EXIT SIGN

INDICATES FIXTURE TYPE; SEE SCHEDULE.

⊕,2 GROUNDED DUPLEX RECEPTACLE (NEMA 5-20R); MOUNTED 18" AFF UON; NUMBER INDICATES CIRCUIT.

GROUNDED QUADRUPLEX RECEPTACLE (NEMA 5-20R); MOUNTED 18" AFF UON.

SPECIAL PURPOSE RECEPTACLE; LETTER INDICATES TYPE; TYPE DEFINED BY NOTATION OR SCHEDULE; MOUNTED 18" AFF UON.

PANELS AND MISC.

LIGHT OR POWER PANEL $\Box\vdash_{\mathsf{FSS}}$ FUSED SAFETY (DISCONNECT) SWITCH

□ H_{NFSS} NON-FUSED SAFETY (DISCONNECT) SWITCH

J

6

Δ

TELEPHONE OUTLET - WALL - MOUNTED 18" AFF, UON PROVIDE 4X4 OUTLET BOX IN WALL WITH 3/4" CONDUIT TO ABOVE CEILING WITH PULL WIRE, WIRING BY OTHERS. \blacksquare

COMPUTER OUTLET - WALL - MOUNTED 18" AFF UON. PROVIDE 4X4 OUTLET BOX IN WALL WITH 3/4" CONDUIT TO ABOVE CEILING WITH PULL WIRE. WIRING BY OTHERS.

ELECTRICAL NOTES


- VERIFY CONDITION AND CAPACITY OF EXISTING ELECTRICAL SERVICE VEHY CONDUIN AND COPPOIT OF ENSINE ELECTRICAL SERVICE (MINMAM TO DAMP SERVICE). RAMOVE AND REPUBLICA S REQUIRED. FROME RION LIGHTING, POWER AND CONTROL CRICOUTING AS REQUIRED.

 ALL WORK TO BE PERFORMED IN ACCORDANCE WITH ALL CURRENT ELECTRICAL CODES.

 EXTERNOR LIGHTNE TO BE CONTROLLED BY TIMECLOCK. INTERNATIC

- MODEL TO I OR APPROVED FOUND.

 PROVIDE LOW VOLTAGE CEILING MOUNTED ULTRASONIC MOTION
 DETECTOR. GREENGATE MODEL ONG-U-1000-R+SP20-MV OR
 APPROVED EQUAL.

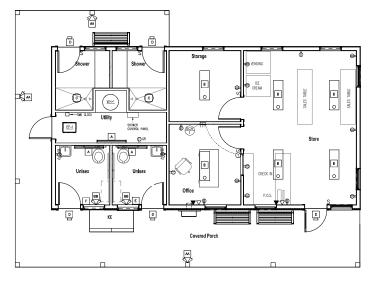

ELECTRICAL POWER PLAN

LIGHTIN	NG FIXTURE SCH	DULE		
MARK	MANUFACTURER	FIXTURE WAKE/WODEL	LAWPING	MOUNTING
A	METALUX	4-BCLED-LD4-28SL-F-UNV-L830-CD-1	32W LED	WALL NOUNTED 8 8'-0" AFF
В	METALUX	4WSNLED-LD4-40SL-UNV-L840-CD1-U	39W LED	CEILING MOUNTED - SURFACE
С	HALO	SLD606-8-30-WH	12.5W LED	CEILING MOUNTED
D	RAB	BRISKS17L-730	14W LED	ABOVE DOOR/BEHIND BEAM/POST
E	LEGRAND	TWHWLECC	1/4W LED	MOUNT 24" AFF
AA.	DUAL-LITE	LZRDB0605	2-5W/WR16	MOUNT TOP 6" T.O. WALL
88	DUAL-LITE	LZ25DI (25 WATT BATTERY)	2-5W/MR16	MOUNT TOP 6" BELOW CEILING



N.H. LIC. NO. 09198

HVAC, Elec. & Plumb. Engineer: Charles P. Buckley, P.E. 500 Depot Street Rumney, NH 03266 tel: (603) 786-9992

Structural Engineer: Fisher Engineering, P.C. 686 Belknap Mountain Road Gilford, NH 03249 tel: (603) 528-7641

NH STATE PARKS

Campground Expansion Project PII Mollidgewock State Park Errol NH 03579

Issue

30% DESIGN

Graphic Scale

Scale: As indicated

Date: Aug. 25, 2023

SSU	is:	
No.	Description	Date

ELECTRICAL PLAN AND DETAILS

E1.01M

Project Number: 23045001

File

			W	ATER	HEATE	R SCI	IEDULE		
MARK	CAPACITY	RECOVERY 0 100 DEG. F.	BTU PER HR. GA	GAS COMN.	GAS MATER				REMARKS
		RISE		CONN.	CONNL	AMPS	VOLT-PHASE	& MODEL	
WH-1	60 GAL.	138 GAL/HR.	120,000	3/4*	1-1/4*	10.0	120-1	A.O., SMITH MCOEL BTH 120	-PROPANE FIRED -POWER VENTED -4" VENT & COMB. AIR PIPES -140 DEG F. DISCHARGE TEMP

PLUMBING NOTES

SCOPE OF WORK

- A. THE CONTRACTOR IS RESPONSIBLE FOR ALL WORK, MATERIALS, AND LABOR TO SATISFY A COMPLETE WORKING SYSTEM WHETHER SPECIFIED OR IMPLIED.
- B. ALL WORK IS TO BE PERFORMED IN STRICT COMPLIANCE WITH THE INTERNATIONAL PLUMBING CODE (2018).
- C. THE CONTRACTOR SHALL, BEFORE SUBMITTING ANY PROPOSAL, EXAMBLE THE PROPOSED SITE AND SHALL DETERMINE FOR HIMSELF THE CONDITIONS THAT MAY EFFECT THE WORK. NO ALLOWANCE SHALL BE MADE IF THE CONTRACTOR FAILS TO MAKE SUCH EXAMINATION.
- D. ALL EQUIPMENT AND MATERIALS SHALL BE AS SPECIFIED OR "APPROVED EQUAL" BY ENGINEER OR ARCHITECT.

SHOP DRAWINGS

2. A SUBMIT MATERIAL LIST AND SHIP DRAVINGS FOR MAJOR EQUIPMENT/FIXTURES TO THE ACCHITECT OR ENGINEER FOR APPROVAL, THE SHIP DRAVINGS SHALL BE CLEARLY TAGGED AND HIGHLIGHTED.

3. DEMESTIC WATER SUPPLY PIPING

- A. ABOVE GROUND MAINS AND BRANCHES COPPER PIPE WITH SOLDER JOINTS. BRANCHES - PEX VITH PEX FITTINGS.
- B. ALL HOT WATER PIPING TO BE INSULATED WITH 1' FIBERGLASS INSULATION.
- FIBERGLASS INSULATION.

 C. ALL COLD WATER PIPING TO BE INSULATED WITH 1/2'
 FDAM INSULATION.
- D. PROVIDE DOMESTIC WATER SHUT-DFFS AT EACH PLUMBING FIXTURE.

4. SANITARY/STORM DRAINAGE AND VENT PIPING

- A. ABDVE GRADE:
 -2' AND BELDW: SCH. 40 PVC WITH SOLVENT JOINTS.
- -3' AND ABOVE SCH. 40 PVC WITH SOLVENT JOINTS.
 B. BELOW GRADE SCH. 40 PVC WITH SOLVENT JOINTS.
- C. PVC PIPING SHALL NOT BE USED IN AIR PLENUM CEILINGS AND SHALL NOT CROSS FIRE RATED WALLS, CEILINGS, OR FLOORS.
- D. DRAINAGE PIPING SHALL BE RUN AS STRAIGHT AS POSSIBLE AND SHALL HAVE LONG TURN FITTINGS.
- E. DRAINAGE PIPING 3' SIZE AND SMALLER SHALL RUN AT A UNIFORM GRADE OF AT LEAST 1/4' PER FOOT, AND PIPING LARGER THAN 3' SHALL BE RUN AT A GRADE OF NO LESS THAN 1/8' PER FOOT.
- F. CONTRACTOR SHALL BE RESPONSIBLE FOR THE PROPER FLASHING OF THE VENT PIPING RUN THROUGH THE ROOF.
- ALL STUB-INS AND/OR SLAB OR WALL PENETRATION TO BE PER INTERNATIONAL PLUMBING CODE. ALL PIPING PENETRATIONS OF BUILDING FOUNDATIONS, FOOTINGS AND WALLS SHALL BE SLEEVED.

6. PIPE SUPPRIES


A ABUVE GRADE
ALL PIPE SHALL BE SUPPORTED FROM THE BUILDING
STRUCTURE IN A NEAT AND WORKMANLIKE MANNER.
THE USE OF WIRE AND PERFERNED NETAL TO SUPPORT
PIPES WILL NOT BE PERMITTED. SHARLING OF PIPE SUPPORTS
SHALL BE AS SPECIFIED IN THE INTERNATIONAL
PILMATING TOTAL


7. MISCELLANEOUS

- A COURDINATE INSTALLATION OF ALL ROOF FLASHING AT ROOF PENETRATION.
- B. DO NOT SCALE THIS DRAWING FOR EXACT DIMENSIONS VERIFY ALL FIGURES, CONDITIONS, AND DIMENSIONS AT THE JOB SITE.
- C. THE PLANDING PLANS ARE INTENDED TO BE DIAGRAMATIC AND ARE DRACED ON DRE MANAPOTURES SOURCE PROPERTY OF THE PROPERTY OF THE WAR ARE NOT INTENDED TO SHAW EVERY TEM IN ITS EXACT LOCATION. THE EXACT DIMPOSIONS OF ALL THE DETAILS OF THE COUPPMENT. THE CONTRACTOR SHALL VERIFY THE ACTUAL DEVISIONS OF THE FOURMENT PROPOSED TO ENSURE THAT THE COUPPMENT PROPOSED TO ENSURE THAT THE COUPPMENT PROPOSED TO ENSURE THAT THE COUPPMENT WILL FIT IN THE AVAILABLE SPACE.
- D. SEAL AND FLASH ALL WALL PENETRATIONS AIR AND WEATHER-TIGHT.

TESTING AND DISINFECTION

A PLUMBING SYSTEMS SHALL BE FLOW AND PRESSURE TESTED & DISINFECTED IN ACCORDANCE WITH STANDARD PRACTICE AND THE INTERNATIONAL PLUMBING CODE.

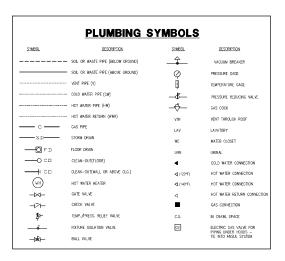

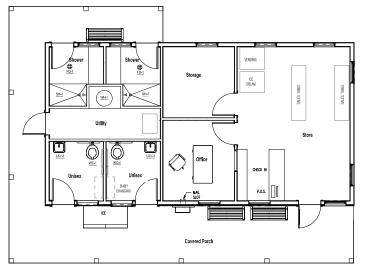

<u>PLUMBING PLAN</u>

	PLUMBING FIXTURE SCHEDULE					
MARK	DESCRIPTION	WANTACTURER - MCOEL #	ACCESSORIES & NOTES	COLOR & FINSH		
				•		
WC-1	ACCESSIBLE TOILET	AMERICAN STANDARD: AFWALL MILLENUM FLOWISE 1.28 CPF FLUSHOMETER MODEL: 2856.128	RUISH WWE: MERROM STANDARD MODEL 6047,121,002 TOLET SEAT: MURROM STANDARD MODEL (F001,100 CARRIER	WHITE		
UW-1	COUNTER SINK	CORINE ADA-COMPLIANT MODEL #810	FAUCET: STIMONS STAMETRY S-20-2-05, TRAFT CHROME PLATED, MICHOS WILVET STIMONS MAXILINE 7-210-OK-W, PIPE CONERS: TRUERRO LAV GLARD 2 E-2 SERIES	WE ZELECTED BY		
SH-1	ACCESSIBLE SHOWER	CUSTOM	DRMR: MATTS FD-1102-A-2-NH-A5-7, HEID: SYMMONS SWETTMEX 4-151 (2 HEXOS & ADA), CONTROLS: SYMMONS SWEETMAX 4-500-BK-4P, OMERIER WILVE: SYMMONS MODEL 2DW, CON-OF: FLUE MANUFACTURING COM OPERALED CONTROL WILVE SYSTEM.	AS SELECTED BY ARCHITECT		
FD-1	FLOOR DRAIN	ZURN: MODEL, FD2-TSP-NP	TRAP PRIMER: PRECISION PLUMBING PRODUCTS PR-500			
_	F EQUAL OR B		ACCEPTED 3 WATER PIPMS SHALL BE INSTALLED TO ALLOW FOR SEASONAL DRAIN DOWN OF THE WATER SYSTEM. PROVINE DRAIN VALUES AS REQUIRED AT LOW POINTS. DRAIN VALUES SHALL BE LOCATED TO LIMIT PUBLIC ACCESS.			
I	(2) PROVIDE ALL N	ecessary trim and fittings required for a complete installation				

CHARLES P. BUCKLEY PROFESSIONAL ENGINEER PRO

N.H. LIC. NO. 09198

HVAC, Elec. & Plumb. Engineer: Charles P. Buckley, P.E. 500 Depot Street Rumney, NH 03266 tel: (603) 786-9992

Structural Engineer: Fisher Engineering, P.C. 686 Belknap Mountain Road Gilford, NH 03249 tel: (603) 528-7641

NH STATE PARKS

Campground Expansion Project PII Mollidgewock State Park 1437 Berlin Road Errol, NH 03579

Issue

30% DESIGN

North

Scale: As indicated

Date: Aug. 25, 2023

Drawn By: CPB
Checked By: CPB

ssues: No Description

No.	Description	Date
_		

PLUMBING PLAN AND DETAILS

Sheet Number:

P1.01M

Project Number: 23045001

File: