MOLLIDGEWOCK STATE PARK

NEW VISITORS RECEPTION CENTER - 60% DESIGN

1437 Berlin Road Errol, NH 03570

SHEET LIST

SHEET NO.	SHEET TITLE
G0.00	COVER SHEET
C1.00 C1.01 C2.00 C3.00 C3.01	EXISTING CONDITIONS DEMOLITION PLAN SITE PLAN EROSION CONTROL DETAILS CIVIL DETAILS
A1.01	MAIN FLOOR REFLECTED CEILING & ROOF PLAN
A1.02	ROOF PLAN
A2.01	EXTERIOR ELEVATIONS
A3.01	BUILDING & WALL SECTIONS
A4.01	INTERIOR ELEVATIONS
A5.01	SCHEDULES
\$1.01	FOUNDATION PLAN
\$2.02	ROOF FRAMING PLAN
M1.01M	MECHANICAL PLAN AND DETAILS
E1.01M	ELECTRICAL PLAN AND DETAILS
P1.01M	PLUMBING PLAN AND DETAILS

SITE



NH STATE PARKS

ISE GROUP

tel: 802.862.0098 fax: 802.865.2440 www.segroup.com

Campground Expansion Project PII Mollidgewock State Park 1437 Berlin Road Errol, NH 03579

60% DESIGN

Graphic Scale

Drawn By: KS

Issu	es:	
No.	Description	Date
1	Name	00/00/00
Н		
Н		
Н		

COVER SHEET


G0.00


Project Number: 23045001 File: I0.00-cover sheet.dwg


LANDSCAPE ARCHITECT CIVIL ENGINEER SE GROUP 1 MILL STREET, SUITE 190 BURLINGTON, VT 05401

HORIZONS ENGINEERING 8836 POMFRET ROAD, SUITE 2A 6 CENTRAL HOUSE ROAD NORTH POMFRET, VT 05053

ARCHITECT SAMYN-D'ELIA ARCHITECTS, P.A. HOLDERNESS, NH 03245

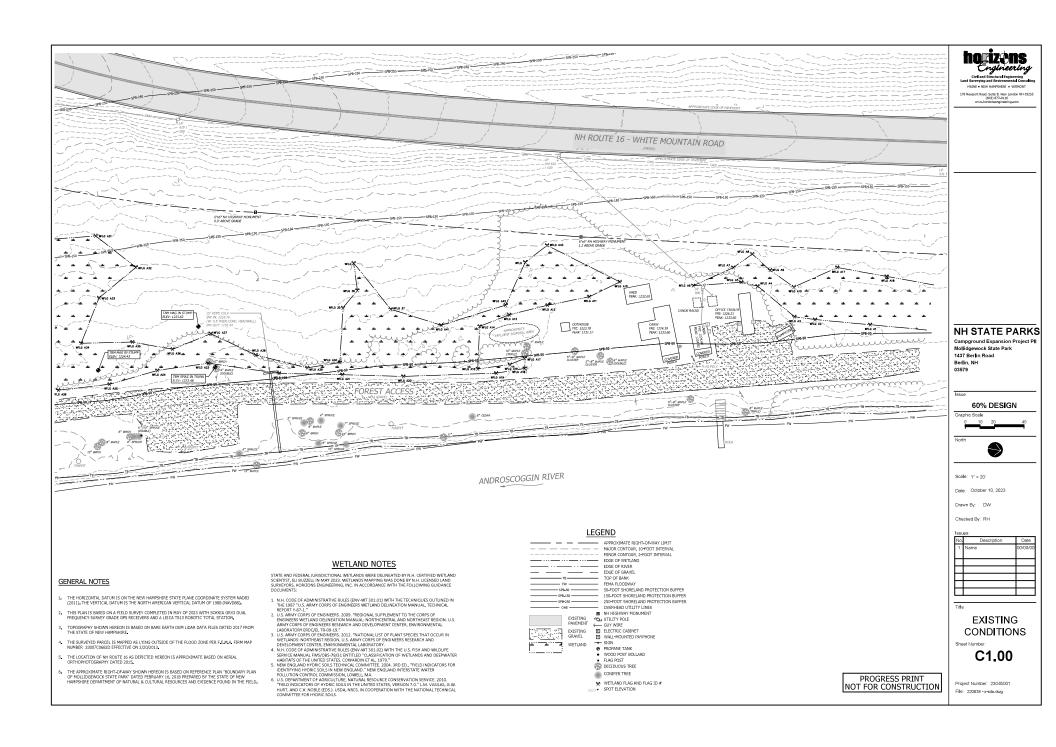

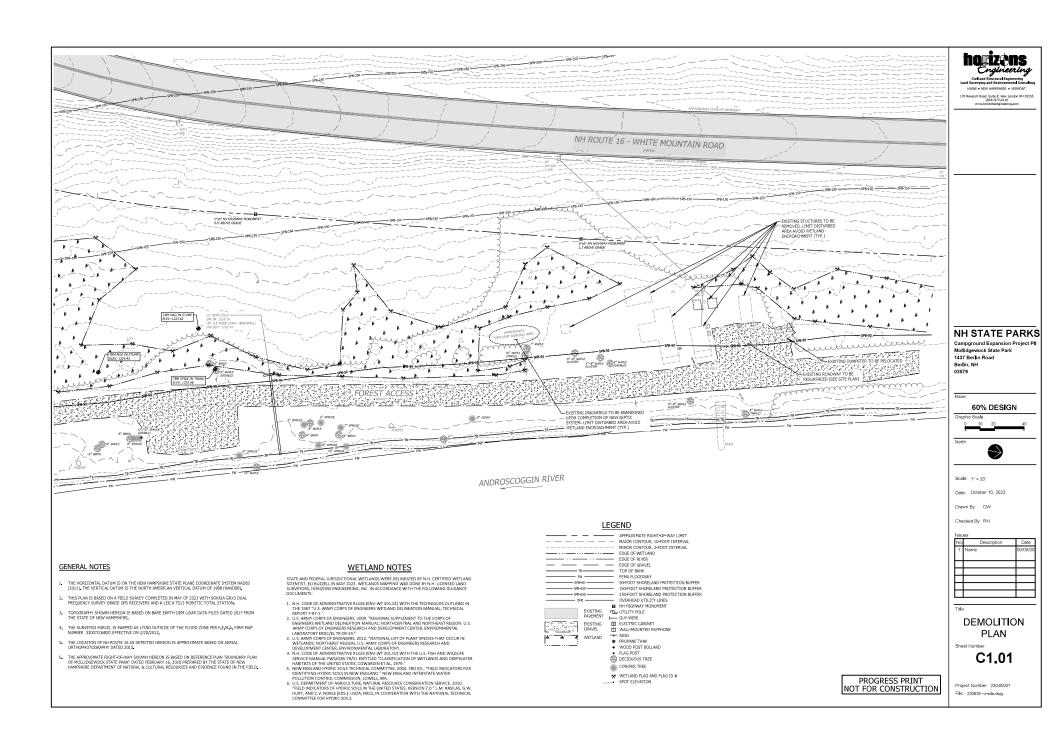

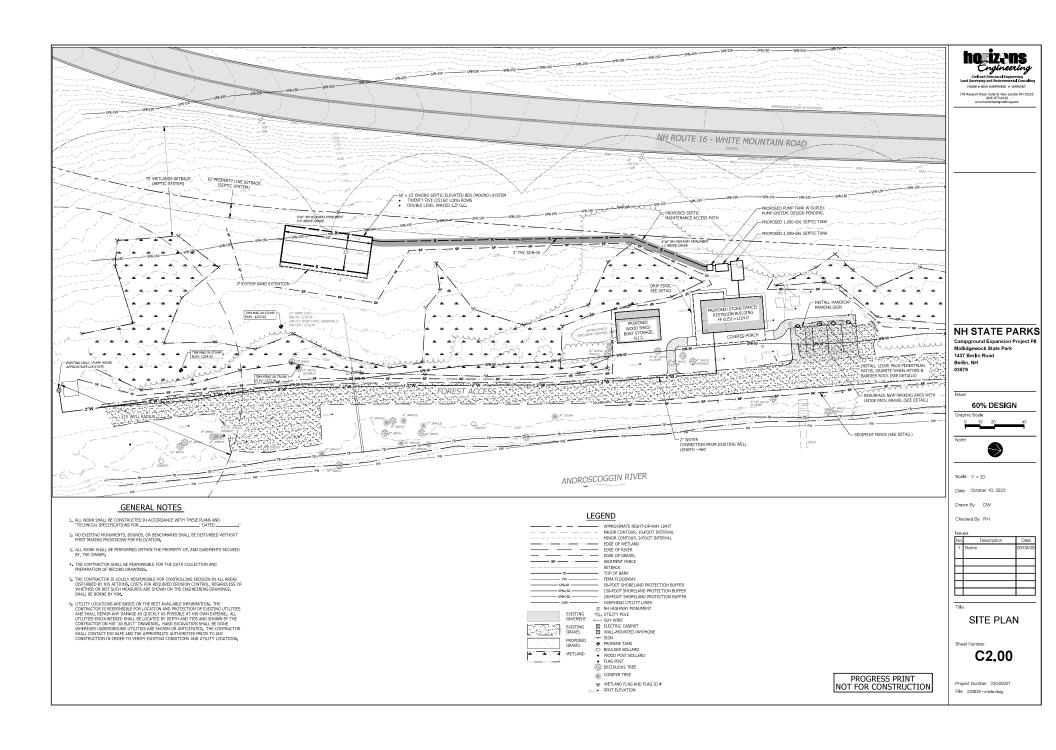

SEEDING RECOMMENDATIONS

GRADING AND SHAPING
A SLOPES SHALL NOT BE STEEPER THAN 2:1; 3:1 SLOPES OR FLATTER ARE PREFERRED, WHERE MOWING WILL BE DONE, 3:1 SLOPES OR FLATTER ARE RECOMMENDED.

2. SEEDBED PREPARATION

A SURFACE AND SEEPING WATER SHOULD BE DRAINED OR DIVERTED FROM THE SITE TO PREVENT DROWNING OR WINTER KILLING OF THE PLANTS.

B. STONES LARGER THAM 4 INCHES AND TRACH SHOULD BE REMOVED BECAUSE THEY INTERFERE WITH SECOND AND FURTHER MAINTENANCE OF THE AREA, WEREE FRESHEE, THE SOIL SHOULD BE AMENDED WITH DOGGMENT WATTER MAINTENANCE TO REPORT A REPORT OF A DEPTH OF A DOGGMENT OF A STONES TO A DEPTH OF A DOGGMENT OF A STONES OF A DOGGMENT OF A STONES OF A DOGGMENT OF A STONES OF A DOGGMENT OF A DOGGMEN

ESTABLISHING VEGETATION
 A. LIME AND FERTILIZES SHOULD BE APPLIED PRIOR TO OR AT THE TIME OF SEEDING AND INCORPORATED IN
THE SOIL. INIDS AND AMOUNTS OF LIME AND FERTILIZER SHOULD BE BASED ON AN EVALUATION OF SOIL
TESTS. WHEN A SOIL TEST IS NOT AVAILABLE, THE FOLLOWING MINIMUM AMOUNTS SHOULD BE APPLIED:

-AGRICULTURAL LIMESTONE, 2 TONS PER ACRE OR 100 LBS. PER 1,000 SO, FT.
-MITROGEN (N), SO LBS. PER ACRE OR 1 LLES, PER 1,000 SO, FT.
-PHOESPHATE (P.O.), 100 LBS. PER ACRE OR 2.2 LBS. PER 1,000 SO, FT.
-POTASH (K,O), 100 LBS. PER ACRE OR 2.2 LBS. PER 1,000 SO, FT.

(NOTE: THIS IS THE EQUIVALENT OF 500 LBS. PER ACRE OF 10-20-20 FERTILIZER OR 1,000 LBS. PER ACRE OF 5-10-10).

B. SEED SHOULD BE SPREAD UNIFORMLY BY THE METHOD MOST APPROPRIATE FOR THE SITE. METHODS INCLUDE BROADCASTING, DRILLING, AND HYDROSEEDING. WHERE BROADCASTING IS USED, COVER SEED WITH .25 INCH OF SOLIO RLESS, BY CULTIPACKING OR RAYING.

	SEEDING	SOIL TYPE					
USE	MIXTURE (SEE 3D)	DROUGHTY	WELL DRAINED	MOD, WELL DRAINED	POORLY DRAINED		
STEEP CUTS AND FILLS, BORROW AND DISPOSAL AREAS	A B C	FAIR POOR FAIR	GOOD GOOD EXCELLENT	GOOD FAIR EXCELLENT	FAIR FAIR POOR		
WATERWAYS, EMERGENCY SPILL- WAYS, AND OTHER CHANNELS WITH FLOWING WATER	A	GOOD	GOOD	GOOD	FAIR		
LIGHTLY USED PARKING LOTS, ODD AREAS, UNUSED LANDS, AND LOW INTENSITY USE RECREATION SITES	A B	G000 G000	GOOD	GOOD FAIR	FAIR POOR		

MIXTURE	PER ACRE	1,000 SQ. FT.
A TALL FESCUE	20	0.45
CREEPING RED FESCUE	20	0.45
REDTOP	2	0.05
TOTAL:	42	0.95
B TALL FESCUE CREEPING RED FESCUE CROWN VETCH OR FLATPEA TOTAL:	15 10 15 OR 30 40 OR 55	0.35 0.25 0.35 OR 0.75 0.95 OR 1.35
C TALL FESCUE	20	0.45
FLATPEA	30	0.75
TOTAL:	50	1.20

E. WHEN SEEDED AREAS ARE MULCHED, PLANTINGS MAY BE MADE FROM EARLY SPRING TO SEPTEMBER 15. WHEN SEEDED AREAS ARE NOT MULCHED, PLANTINGS SHOULD BE MADE FROM EARLY SPRING TO MAY 20 OR FROM JULIST 10 TO SEPTEMBER 1.

F, TEMPURARY	SEELAING RAI	ES:	
SPECIES	POUNDS PER ACRE	POUNDS PER 1,000 SQ. FT.	REMARKS
WINTER RYE	112	2,5	BEST FOR FALL SEEDING, SEED FROM AUGUST TO SEPTEMBER 5TH FOR BEST COVER. SEED TO A DEPTH OF 1 INCH.
OATS	80	2.0	BEST FOR SPRING SEEDING. SEED NO LATER THAN MAY 15TH FOR SUMMER PROTECTION. SEED TO A DEPTH OF 1 INCH.
ANNUAL RYEGRASS	40	1,0	GROWS QUICKLY, BUT IS OF SHORT DURATION. USE WHERE APPEARANCES ARE NOT IMPORTANT. SEED EARLY SPRING AND/OR BETWEEN AUGUST 15TH AND SEPTEMBER 15TH. COVER SEED WITH NO MORE THAN 0.25 INCH OF SOIL.
PERENNIAL RYEGRASS	30	0.7	GOOD COVER WHICH IS LONGER LASTING THAN ANNUAL RYEGRASS, SEED BETWEEN APRIL 1ST AND JUNE IST AND JUNE IST AND JUNE IST AND GOOD SETVEMENT STH. MULCHING WILL ALLOW SEEDING THROUGHOUT THE GROWING SERSON, SEED TO A DEPTH OF APPROXIMATELY OS, INCH.


MULCH
 A. HAY, STRAW, OR OTHER MULCH, WHEN NEEDED, SHOULD BE APPLIED IMMEDIATELY AFTER SEEDING.

B. MULCH WILL BE HELD IN PLACE USING APPROPRIATE TECHNIQUES FROM THE BEST MANAGEMENT PRACTICE FOR MULCHING.

MAINTENANCE TO ESTABLISH A STAND
 A PLANTED AREAS SHOULD BE PROTECTED FROM DAMAGE BY FIRE, GRAZING, TRAFFIC, AND DENSE WEED
GROWTH.

B. FERTILIZATION NEEDS SHOULD BE DETERMINED BY ON SITE INSPECTIONS. SUPPLEMENTAL FERTILIZER IS USUALLY THE KEY TO FULLY COMPLETE THE ESTABLISHMENT OF THE STAND BECAUSE MOST PERENNIALS TAKE 2 TO 3 YEARS TO BECOME STRAILISHED.

C. IN WATERWAYS, CHANNELS, OR SWALES WHERE UNIFORM FLOW CONDITIONS ARE ANTICIPATED, OCCASIONAL MOWING MAY BE NECESSARY TO CONTROL GROWTH OF WOODY VEGETATION.

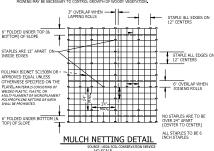

EROSION CONTROL GENERAL NOTES

A. KEEP SITE MODIFICATION TO A MINIMUM

1. CONSIDER FITTING THE BUILDINGS AND STREETS TO THE NATURAL TOPOGRAPHY. THIS REDUCES THE NEEP FOR CUTS AND FILLS. AVOID EXTENSIVE GRADING THAT WOULD ALTER DRAINAGE PATTERNS OR CREATE VERY STEEP SLOPES.

2. EXPOSE AREAS OF BARE SOIL TO EROSIVE ELEMENTS FOR THE SHORTEST TIME POSSIBLE.

SAVE AND PROTECT DESIRABLE EXISTING VEGETATION WHERE POSSIBLE. ERECT BARRIERS
TO PREVENT DAMAGE FROM CONSTRUCTION EQUIPMENT.

LIMIT THE GRADES OF SLOPES SO VEGETATION CAN BE EASILY ESTABLISHED AND MAINTAINED.

5. AVOID SUBSTANTIAL INCREASE IN RUNOFF LEAVING THE SITE.

B. MINIMIZE POLLUTION OF WATER DURING CONSTRUCTION ACTIVITIES 1. STOCKPILE TOPSOIL REMOVED FROM CONSTRUCTION AREA AND SPREAD OVER ANY DISTURBED AREAS PRIOR TO REVEGETATION. TOPSOIL STOCKPILES MUST BE PROTECTED FROM BROSION.

- PROTECT BARE SOIL AREAS EXPOSED BY GRADING ACTIVITIES WITH TEMPORARY VEGETATION OR MULCHES.
- USE SEDIMENT BASINS TO TRAP DEBRIS AND SEDIMENT WHICH WILL PREVENT THESE MATERIALS FROM MOVING OFF SITE.
- USE DIVERSIONS TO DIRECT WATER AROUND THE CONSTRUCTION AREA AND AWAY FROM EROSION PRONE AREAS TO POINTS OF SAFE DISPOSAL.
- 5. USE TEMPORARY CULVERTS OR BRIDGES WHEN CROSSING STREAMS WITH EQUIPMENT.
- PLACE CONSTRUCTION FACILITIES, MATERIALS, AND EQUIPMENT STORAGE AND MAINTENANCE AREAS AWAY FROM DRAINAGE WAYS.

- C. PROTECT AREA AFTER CONSTRUCTION.

 1. ESTABLISH GRASS OR OTHER SUITABLE VEGETATION ON ALL DISTURBED AREAS. SELECT SPECIES ADAPTED TO THE SITE CONDITIONS AND THE FUTURE USE OF THE AREA. FINAL GRADES SHALL BE SEEDED WITHIN 72 HOURS. STABILIZATION SHALL BE DEFINED AS 85%
- MAINTAIN VEGETATED AREAS USING PROPER VEGETATIVE BEST MANAGEMENT PRACTICES DURING THE CONSTRUCTION PERIOD.
- MAINTAIN NEEDED STRUCTURAL 'BEST MANAGEMENT PRACTICES' AND REMOVE SEDIMENT FROM DETENTION PONDS AND SEDIMENT BASINS AS NEEDED.
- DETERMINE RESPONSIBILITY FOR LONG TERM MAINTENANCE OF PERMANENT 'BEST MANAGEMENT PRACTICES'.
- IF CONSTRUCTION IS ANTICIPATED DURING WINTER MONTHS, REFER TO 'COLD WEATHER SITE STABILIZATION REQUIREMENTS'

D. INVASIVE SPECIES AND FIGURITY DUST

1. THE PROJECT SHALL NOT CONTRIBUTE TO THE SPREAD OF INVASIVE SPECIES, PRIOR TO
CONSTRUCTION, THE CONTROCTOR SHALL TAKE MICESSARY MEASURES TO REQUIT THEIR
INVASIVE SPECIES, AND IF FOUND SHALL TAKE INCESSARY MEASURES TO REQUIT THEIR
THE PRIOR OF THE PROJECT OF THE REPORT THE REPORT OF THE PROJECT OF A PRIOR TO THE PROJECT OF T

2. FUGITIVE DUST SHALL BE CONTROLLED IN ACCORDANCE WITH ENV-A 1000.

COLD WEATHER SITE STABILIZATION REQUIREMENTS


TO ADEQUATELY PROTECT WATER QUALITY DURING COLD WEATHER AND DURING SPRING RUNOFF, THE FOLLOWING ADDITIONAL STABILIZATION TECHNIQUES SHALL BE EMPLOYED DURING THE PERIOD FROM OCTOBER 15 THROUGH MAY 1:

- THE AREA OF EXPOSED, UNSTABILIZED SOIL SHALL BE LIMITED TO 1 ACRE AND SHALL BE PROTECTED AGAINST ERGOLON BY THE METHODS DESCRIBED IN THIS SECTION PRIOR TO ANY THAW OR SPRING MELT EVENT. THE ALLOWABLE AREA OF EXPOSED SOIL MAY BE INCREASED IF A WINTER CONSTRUCTION FLAN, DEVELOPED BY A QUALIFIED ENGINEER OR A CPESC SPECIALIST. IS REVIEWED AND APPROVED BY NHDES.
- 2. ALL PROPOSED VEGETATED AREAS HAVING A SLOPE OF LESS THAN 15% WHICH DO NOT EXHIBIT A MINIMUM OF 85% VEGETATIVE GROWTH BY OCTOBER 15, OR WHICH ARE DISTURBED AFFEC OCTOBER 15, SHALL BE SEEDED AND COVERED WITH 3 TO 4 TONS OF HAY OR STRAW MULCH FER ACRE, SECURED WITH ANCHORED NETTING OR TACKIFIER, OR 2 INCHES OF EROSION CONTROL MIX MEETING THE CRITERIA OF ENV-WQ 1506.05(D) THROUGH (H)
- 3. ALL PROPOSED VEGETATED AREAS HAVING A SLOPE OF GREATER THAN 15% ALL PREVISED YESSER ALLD MICHS HAVING A SLUDE OF GREATER IN HIM 15% WHICH DO NOT SHEBIT A MINIMUM OF 95% VEGETATIVE GROWTH BY OCTOBER 15, OR WHICH ARE DISTURBED AFTER OCTOBER 15, HALL SEEDED AND COVERED WITH PROPERLY INSTALLED AND ANA-ORDE EROSION CONTROL MIX METHOD OR WITH A MINIMUM A HICH TRICKIESS OF EROSION CONTROL MIX MEETING THE CULTERA OF ENWAYQ 150C(6)(1) THROUGH (H)
- 4. INSTALLATION OF ANCHORED HAY MULCH OR EROSION CONTROL MIX, MEETING
- 5. INSTALLATION OF EROSION CONTROL MATTING SHALL NOT OCCUR OVER SNOW PROTECTIVE OF GREATER THAN ONE INCH IN DEPTH OR ON FROZEN GROUND.

 STATEMAN OF THE STATEM
- ALL PROPOSED STABILIZATION IN ACCORDANCE WITH NOTES 2 OR 3 ABOVE SHALL BE COMPLETED WITHIN 1 DAY OF ESTABLISHING THE GRADE THAT IS FINAL OR THAT OTHERWISE WILL EXIST FOR MORE THAN 5 DAYS.
- ALL DITCHES OR SWALES WHICH DO NOT EXHIBIT A MINIMUM OF 85% VECETATIVE GROWTH BY OCTOBER 15, OR WHICH ARE DISTURBED AFTER OCTOBER 15, SHALL BE STABLIZED TEMPORABLY WITH STONE OR REGISTON COMPROL BLANKETS APPROPRIATE FOR THE DESIGN FLOW CONDITIONS, AS DETERMINED BY THE CONVERSE SMIKERING CONSULTANT.
- 8. AFTER OCTOBER 15, INCOMPLETE ROAD OR PARKING AREAS WHERE ACTIVE CONSTRUCTION OF THE ROAD OR NORKING AREA HAS STOPPED FOR THE WINTER SEASON SHALL BE PROTECTED WITH A MINIMUM 3 INCH LAYER OF BASE COURSE GRAVELS MEETING THE GRADATION REQUIREMENTS OF INDIOT STANDARD SPECIFICATION FOR ROAD AND BRIDGE CONSTRUCTION, 2016, ITEM

LEVEL LIP SPREADER INSTALLATION

- CONSTRUCT THE LEVEL SPREADER LIP ON A ZERO PERCENT GRADE TO INSURE UNIFORM SPREADING OF RUNOFF.
- 2. LEVEL SPREADER SHALL BE CONSTRUCTED ON UNDISTURBED SOIL AND NOT ON
- AN EROSION STOP SHALL BE PLACED VERTICALLY A MINIMUM OF SIX INCHES DEEP IN A SLIT TRENCH ONE FOOT BACK OF THE LEVEL LIP AND PARALLEL TO THE LIP. THE EROSION STOP SHALL EXTEND THE ERVIRSE LENGTH OF THE LEVEL LIP.
- THE ENTIRE LEVEL LIP AREA SHALL BE PROTECTED BY PLACING TWO STRIPS OF JUTE OR EXCELSIOR MATTING ALONG THE LIP. EACH STRIP SHALL OVERLAP THE EROSION STOP BY AT LEAST SIX INCHES.
- THE ENTRANCE CHANNEL TO THE LEVEL SPREADER SHALL NOT EXCEED A 1 PERCENT GRADE FOR AT LEAST 50 FEET BEFORE ENTERING INTO THE SPREADER.
- THE FLOW FROM THE LEVEL SPREADER SHALL OUTLET ONTO STABILIZED AREAS WATER SHOULD NOT RE-CONCENTRATE IMMEDIATELY BELOW THE SPREADER.
- 7. PERIODIC INSPECTION AND REQUIRED MAINTENANCE SHALL BE PERFORMED.
- 8. PROTECTIVE MATERIAL AND EROSION STOP SHALL BE NORTH AMERICAN GREEN C125 EROSION CONTROL BLANKET OR APPROVED EQUAL.

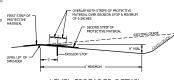

LEVEL SPREADER DETAIL

NO SCALE SOURCE: ROCKINGHAW COUNTY CONSERVATION SERVICE

CONSTRUCTION SEQUENCE

- PREPARE AN EROSION CONTROL PLAN OR A STORMWATER POLLUTION PREVENTION PLAN (SWPPP) IN ACCORDANCE WITH LOCAL, STATE, AND FEDERAL REQUIREMENTS.
- 2. INSTALL CONSTRUCTION ENTRANCE, SEE DETAIL.
- 3. CUT AND CLEAR TREES WITHIN THE CLEARING LIMITS.
- 4. INSTALL SEDIMENT FENCES, ROCK CHECK DAMS, AND OTHER APPROPRIATE EROSION CONTROL MEASURES AT LOCATIONS SHOWN ON THE PLANS AND AS NEEDED.
- 5. GRUB SITE WITHIN GRADING LIMITS.
- 6. STRIP AND STOCKPILE TOPSOIL AND INSTALL EROSION CONTROL MEASURES.
- INSTALL/ADJUST SEDIMENT FENCE, CHECK DAMS, AND HAYBALES, AS REQUIRED.
- CONSTRUCT PERMANENT STORMWATER CONTROLS AS SOON AS PRACTICAL
 DO NOT DIRECT STORMWATER TOWARD TREATMENT BASINS, PONDS, SWALES
 DITCHES AND LEVEL SPREADERS UNTIL THEY HAVE BEEN STABILIZED.
- PROCEED WITH WORK, LIMITING THE DURATION OF DISTURBANCE. THE MAXIMUM OF UNCOVERED DISTURBED EARTH AT ANY ONE TIME IS FIVE ACRES. THE MAXIMUM LEWISTH OF TIME THAT DISTURBED EARTH MAY BE LEFT UNSTABILIZED IS 45 DAYS.

BEGIN SEEDING AND MULCHING IMMEDIATELY AFTER GRADING. ALL DISTURBED AREAS SHALL BE STABILIZED WITH APPROVED METHODS WITHIN 72 HOURS OF ACHIEVING FINISHED GRADE.

AN AREA SHALL BE CONSIDERED STABLE IF ONE OF THE FOLLOWING HAS OCCURRED:

A) BASE COURSE GRAVELS HAVE BEEN INSTALLED IN AREAS TO BE PAMED;
B) AN KINAMUM OF 85% VACETATED GROWTH HAS BEEN ESTABLISHED;
C) AN MINIMUM OF 30° OR MONE-ROSINE MATERIALS, SOLVE AS STONE OR
KIJFRAP HAS BEEN INSTALLED; OR
D) EROSINO CONTROL ELAWERS HAVE BEEN PROPERLY INSTALLED.

- INSPECT ALL EROSION CONTROL MEASURES ON A DAILY BASIS AND AFTER EVERY 0.5 INCHES OF PRECIPITATION. MAINTAIN SEDIMENT FENCE, SEDIMENT TRAPS, HAY BALES, ETC., AS NECESSARY.
- 13. PLACE TOPSOIL, SEED AND MULCH.
- 14. COMPLETE ALL REMAINING PERMANENT EROSION CONTROL STRUCTURES.
- MONITOR THE SITE AND MAINTAIN STRUCTURES AS NEEDED UNTIL FULL VEGETATION IS ESTABLISHED.

NH STATE PARKS

horizans

176 Newport Road, Suite 8; New London NH 03255 (603) 877-0116

Engineering

Campground Expansion Project PI Mollidgewock State Park 1437 Berlin Road Berlin, NH

60% DESIGN

Scale: N/A Date: October 10, 2023


Drawn By: DW




EROSION CONTROL **DETAILS**

C3.00


Project Number: 23045001 File: 220838 - x-site.dwg

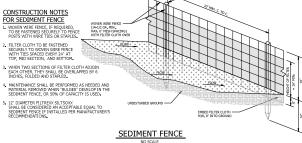

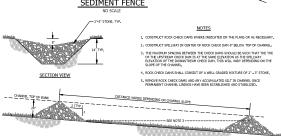


ROCK CHECK DAM DETAIL


NO SCALE

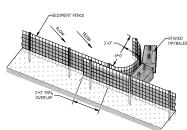


SEDIMENT FENCE POCKET PROGRESS PRINT NOT FOR CONSTRUCTION

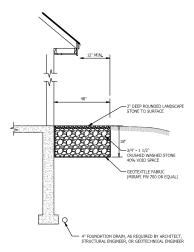


INFILTRATING STONE DRIP EDGE DETAIL

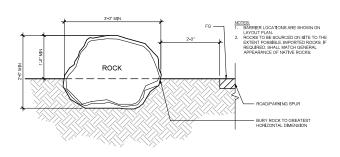


BARRIER ROCK DETAIL

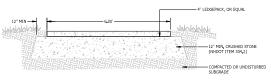

TYPICAL LEDGE PACK WALKWAY SECTION

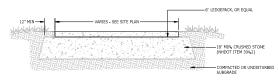

TYPICAL LEDGE PACK PARKING AREA SECTION DETAIL

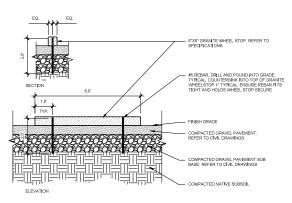

GRANITE WHEEL STOP DETAIL

horizens Ingineering

Civil and Structural Engineering
Land Surveying and Environmental Consulting
MAINE • NEW HAMP-REE • VERMONT

176 Newport Road, Suite S, New London RH 03255
(63) 877-0116
www.hantborengripering.com

NH STATE PARKS

Campground Expansion Project Pli Mollidgewock State Park 1437 Berlin Road Berlin, NH 03579

Issua

60% DESIGN

Scale: N/A

Date: October 10, 2023

Drawn By: DW

Checked By: RH

	Issu	ies:	
	No.	Description	Date
	1	Name	00/00/00
	П		
	П		

Title

CIVIL DETAILS

Sheet Numbe

C3.01

PROGRESS PRINT
NOT FOR CONSTRUCTION

Project Number: 23045001
File: 220838 -x-site.dwg

- INTERNATIONAL BUILDING CODE (IBC) 2018 EDITION, AS AMENDED
- NEW HAMPSHIRE SAF-C GOOD FIRE CODE NPPA I FIRE CODE - 20 IB EDITION - NPPA I OT UPE SAPETY CODE - 20 IB EDITION - CHAPTER 36, "NEW MERCANTIUS"
- INTERNATIONAL ENERGY CONSERVATION CODE (ECC) 2018 EDITION

 ~ INTERNATIONAL PLUMENICS CODE (MC) 2018 EDITION

 INTERNATIONAL MECHANICAL CODE (MC) 2018 EDITION

 ~ NATIONAL ELECTRIC CODE (MC) 2020
- -- APPLICABLE ACCESSIBILITY CODES 4 STANDARDS:
 ICC A I 17.1-2003 ACCESSIBLE 4 USABLE BUILDINGS 4 PACILITIES

PROPOSED FACILITY:

- ~ OVERALL FACILITY FIRE PROTECTION
- ~ OCCUPANCY CLASSIFICATION: IBC BUSINESS (B); LSC CHAPTER 38, "NEW PLUMBING REQUIREMENTS:
- ~ CONSTRUCTION CLASSIFICATION: TYPE VB (COMBUSTIBLE, NO RATING) ~ BUILDING STORIES & HEIGHT (IBC TABLES 504.3 4 504.4)

- ~ BUILDING AREA (IBC TABLE 506.2)
- ALLOWARDE AREA (15T FLOOR PLAN): 9,000 GSF PROPOSED AREA (15T FLOOR PLAN): 1,585 GSF = COMPLES
- TOTAL PROPOSED GROSS FLOOR AREAS: 1,585 SF

FIRE RESISTANCE RATINGS REQUIREMENTS:


- BUILDING ELEMENTS (TABLE 601) PULDING ELEMENTS (TABLE 601) - PRIMARY SPINCTURAL PRAME: 0 HR - EXTERIOR BEARING WALLS: 0 HR - INTERIOR BEARING WALLS: 0 HR - EXTERIOR NON-BEARING WALLS: 0 HR - INTERIOR NON-BEARING WALLS: 0 HR - PLOOR CONSTRUCTION: 0 HR - ROOF CONSTRUCTION: 0 HR

MEANS OF EGRESS REQUIREMENTS:

- MAXIMUM TRAVEL DISTANCE: 200 FEET (38.2.6.3)
 MAXIMUM DEAD-FIND CORRIDOR LENGTH: 20 FEET (38.2.5.2)
 MAXIMUM COMMON PART OF TRAVEL: 75 FEET (38.2.5.3.1)
 MITERIOR FRISH, WALLS AND CELING: A, B, or C (38.3.3)
 INTERIOR FRISH, WALLS AND CELING: A, B, or C (38.3.3)
- ENERGY CODE MINIMUM THERMAL ENVELOPE REQUIREMENTS:

- ALLOWAGE FIDERS: 2 STORES
 PEOPERS DISCRES: 1 STORE CLARIES
 PEOPERS DISCRES: 1 STORE CLARIES
 ALLOWAGE FIDERS: 40 or 10 AVENUE RIGHT OF HISPEST ROOF PLANS
 PEOPERS DISCRES: 1 STORE CLARIES
 ALLOWAGE FIDERS: 40 or 10 AVENUE RIGHT OF HISPEST ROOF PLANS
 PEOPLOS PEOPLE: 150 CLARIES
 CLARIES CLARIES CLARIES
 CLARIES CLARIES CLARIES
 CLARIES CLARIES CLARIES CLARIES
 CLARIES CLARIES CLARIES CLARIES
 CLARIES CLARIES CLARIES CLARIES CLARIES CLARIES CLARIES CLARIES CLARIES CLARIES CLARIES CLARIES CLARIES CLARIES CLARIES CLARIES CLARIES CLARIES CLARIES -

CODE SUMMARY

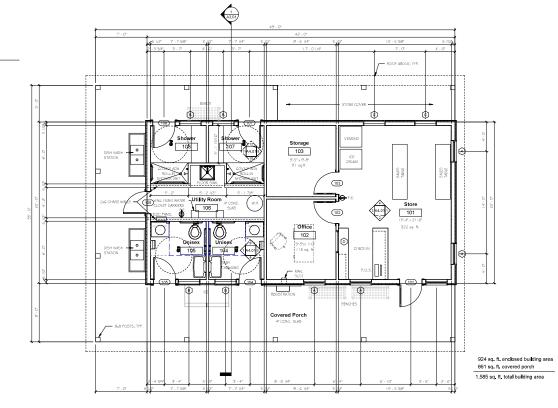

SAMYN - D'ELIA ARCHITECTS, P.A

P.O. Box 229 Holderness, NH 03245 tel: (603) 968-7133

FOR REVIEW OCT, 11, 2023

NOT FOR CONSTRUCTION

HVAC, Elec. & Plumb, Engineer: Charles P. Buckley, P.E. 500 Depot Street Rumney, NH 03266 tel: (603) 786-9992

Structural Engineer: Fisher Engineering, P.C. 686 Belknap Mountain Road Gilford, NH 03249 tel: (603) 528-7641

NH STATE PARKS

Campground Expansion Project PII Mollidgewock State Park 1437 Berlin Road Errol, NH 03579

 \oplus

Teerse

60% DESIGN

Scale: As indicated

Date: Oct. 11, 2023

Drawn By: MR

Checked By: WD




MAIN FLOOR PLAN


Sheet Number

A1.01

MAIN FLOOR PLAN

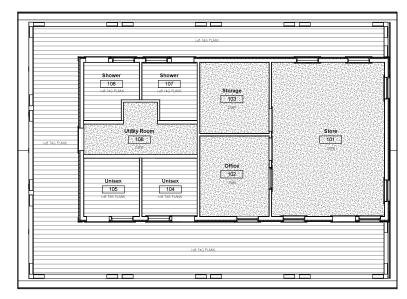

MAIN LEVEL REFLECTED CEILING PLAN Scale: 1/4" = 1-0"

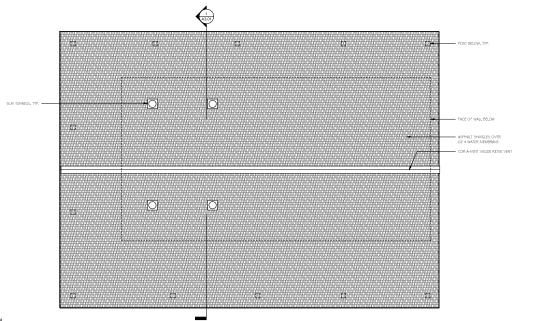

SAMYN - D'ELIA ARCHITECTS, P.A.

P.O. Box 229 Holderness, NH 03245 tel: (603) 968-7133

FOR REVIEW OCT, 11, 2023

NOT FOR CONSTRUCTION

HVAC, Elec. & Plumb. Engineer: Charles P. Buckley, P.E. 500 Depot Street Rumney, NH 03266 tel: (603) 786-8992

Structural Engineer: Fisher Engineering, P.C. 686 Belknap Mountain Road Gilford, NH 03249 tel: (603) 528-7641

NH STATE PARKS

Campground Expansion Project PII Mollidgewock State Park 1437 Berlin Road Errol, NH 03579

60% DESIGN

 \oplus

Scale: 1/4" = 1'-0"

Date: Oct. 11, 2023

Drawn By: MR Checked By: WD


ssues:		_
No.	Description	Date
\neg		
_		
-		_
_		
-		

MAIN FLOOR REFLECTED CEILING & ROOF PLAN

Sheet Number:

A1.02

ROOF PLAN
Scale: 1/4" = 1'-0"

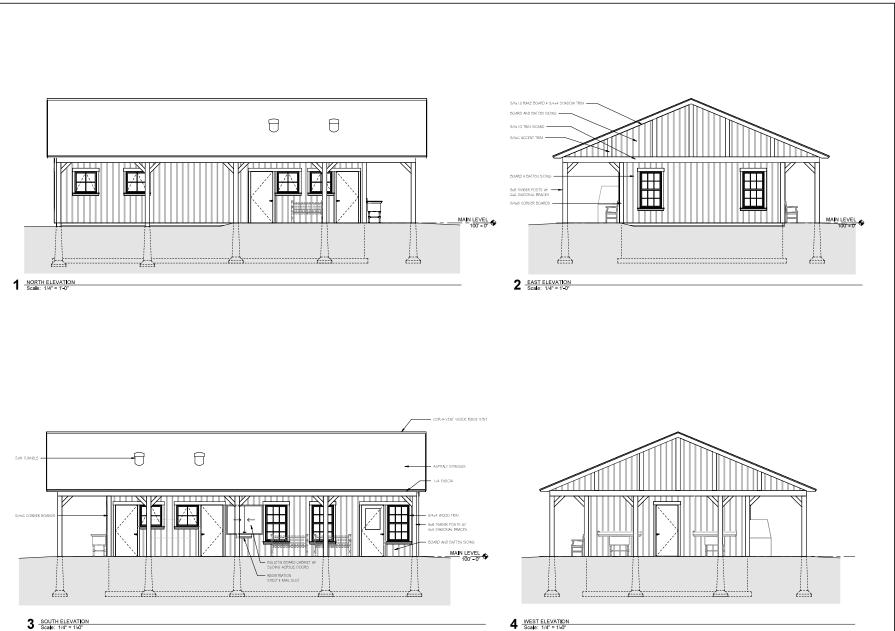

SAMYN - D'ELIA ARCHITECTS, P.A.

P.O. Box 229 Holderness, NH 03245 tel: (603) 968-7133

FOR REVIEW OCT. 11, 2023

NOT FOR CONSTRUCTION

HVAC, Elec. & Plumb, Engineer: Charles P. Buckley, P.E. 500 Depot Street Rumney, NH 03266 tel: (603) 786-9992

Structural Engineer: Fisher Engineering, P.C. 686 Belknap Mountain Road Gilford, NH 03249 tel: (603) 528-7641

NH STATE PARKS

Campground Expansion Proj Mollidgewock State Park 1437 Berlin Road Errol, NH 03579

60% DESIGN

Scale: 1/4" = 1'-0"


Date: Oct. 11, 2023 Drawn By: MR


Date


EXTERIOR ELEVATIONS

Sheet Number:

A2.01

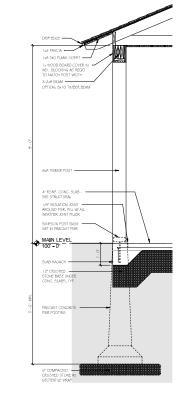

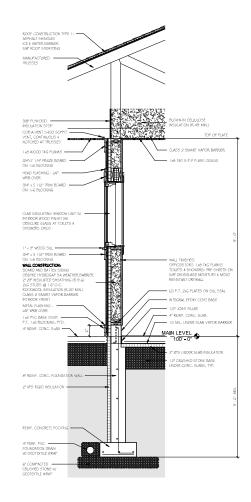

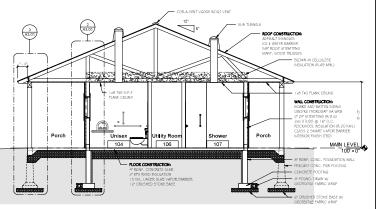

SAMYN - D'ELIA ARCHITECTS, P.A.

P.O. Box 229 Holderness, NH 03245 tel: (603) 968-7133

FOR REVIEW OCT. 11, 2023

NOT FOR CONSTRUCTION

HVAC, Elec. & Plumb, Engineer: Charles P. Buckley, P.E. 500 Depot Street Rumney, NH 03266 tel: (603) 786-9992

Structural Engineer: Fisher Engineering, P.C. 686 Belknap Mountain Road Gilford, NH 03249 tel: (603) 528-7641

NH STATE PARKS

Campground Expansion Project PII Mollidgewock State Park 1437 Berlin Road Errol, NH 03579

60% DESIGN

Scale: As indicated

Date: Oct, 11, 2023

Drawn By: MR

Date


BUILDING & WALL SECTIONS


Sheet Number


A3.01

2 WALL SECTION 1
Scale: 3/4" = 1'-0"


BUILDING SECTION
Scale: 1/4" = 1'-0"

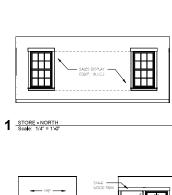

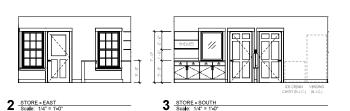

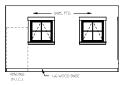



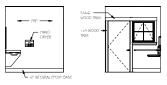

5 UNISEX - NORTH Scale: 1/4" = 1'0"

6 UNISEX - EAST Scale: 1/4" = 1'-0"













10 SHOWER - EAST Scale: 1/4" = 1'-0" 1 1 SHOWER - SOUTH Scale: 1/4" = 1'-0" 9 SHOWER - NORTH Scale: 1/4" = 1'-0" 12 SHOWER - WEST Scale: 1/4" = 1'-0" FOR REVIEW OCT. 11, 2023 NOT FOR CONSTRUCTION

SAMYN - D'ELIA ARCHITECTS, P.A. P.O. Box 229 Holderness, NH 03245 tel: (603) 968-7133

HVAC, Elec. & Plumb, Engineer: Charles P. Buckley, P.E. 500 Depot Street Rumney, NH 03266 tel: (603) 786-9992

Structural Engineer: Fisher Engineering, P.C. 686 Belknap Mountain Road Gilford, NH 03249 tel: (603) 528-7641

NH STATE PARKS

Campground Expansion Project PII Mollidgewock State Park 1437 Berlin Road Errol, NH 03579

60% DESIGN

Scale: 1/4" = 1'-0"

Date: Oct, 11, 2023

Drawn By: MR

No.	Description	Date

INTERIOR ELEVATIONS

Sheet Number:

A4.01

	FINISH SCHEDULE										
ROOM											
NUMBER	ROOM NAME	PLOOR PINISH	BASE PINISH	NORTH WALL	EAST WALL	SOUTH WALL	WEST WALL	CEILING FINISH	COMMENTS		
107	Store	LUXURY YINYL PLANK	Lx6 WOOD	5/8" GWB	5/8" GWB	5/8" GWB	5/8" GWB	5/8" GWB			
102	Office	LUXURY VINYL PLANK	Lx6 WOOD	5/8" GWB	S/8" GWB	5/8" GWB	5/8" GWB	5/8" GWB			
103	Storage	SEALED CONCRETE	4" VNY).	5/8" GWB	5/8° GWB	5/8" GWB	5/8° GWB	5/6" GWB			
104	Unsex	EPOXY	G* INTEGRAL EPOXY	FRP ON 5/81 GWB	1x8 T#G PLANKS						
105	Unsex	EPOXY	G" INTEGRAL EPOXY	FRP ON 5/8" GWB	1x8 T4G PLANKS						
106	Utility Room	SEALED CONCRETE	-					5/8" GWB			
107	Shower	EPOXY	G" INTEGRAL EPOXY	FRP ON 5/81 GWB	FRP ON 5/8" GWB	FRP ON 5/81 GWB	FRP ON 5/8" GWB	1x8 T4G PLANKS			
108	Shower	PPCWY	CLINIFICRAL PROPY	PRE ON SIR! CWR	PRP ON SIA! CWA	PRP ON SIR! OVE	PRP ON SIR! CVA	LASTAG PLANES			

	DOOR SCHEDULE									
OPENING	WIDTH	HEIGHT	THICKNESS	DOOR TYPE	MATERIAL	FINSH	FRAME MATERIAL	FRAME FINISH	COMMENTS	
101	31 - 01	7'-0'	1.3/4*	HALF GLASS	FIBERGLASS	PREFIN.	FIBERGLASS	PREFIN.		
102	3' - 0"	7' - 0"	1.3/4"	6 PANEL	WOOD	STAINED	WOOD	STAIN		
103	3' - 0"	7'-0"	1.3/4*	G PANEL	WOOD	STANED	WOOD	STAIN		
104	3' - 0"	7'-0"	1.3/4*	FLUSH	FIBERGLASS	PREFIN.	FIBERGLASS	PREFIN.		
105	3' - 0"	7'-0'	1.3/4*	PLU5H	FIERGLASS	PREFIN.	FIBERGLASS	PREPIN.		
106	3' - 0"	7'-0"	1.3/4*	fLUSH	FIBERGLASS	PREFIN.	fiBERGLASS	PREMN.		
107	3' - 0"	7' - 0"	1.3/4*	PLUSH	FIBERGLASS	PREFIN.	FIBERGLASS	PREFIN.		
108	3' - 0"	7'-0"	1.3/4*	FLUSH	FIEERGLASS	PRETIN.	FIBERGLASS	PREFIN.		

WINDOW SCHEDULE									
MARK	WIDTH	HEIGHT	TYPE	MODEL	COMMENTS	COUNT			
A	3'-0 1/2"	5' - 0 1/4"	Ejevate Doubje Hung	ELDH3660		- 6			
В	3'-1"	2"-115/8"	Elevate Awning	ELAWN3735	WITH OBSCURE GLASS	- 4			
С	3'-1"	2" - 11 5/8"	Elevate Awning	ELAWN3735		2			
D	3'-0 1/2"	4"-0.1/2"			FIXED SINGLE GLASS	1			

DITERIOR WINDOWS TO BE ELEVATE BY MARVIN.
 INTERIOR WINDOWS WITH SINGLE GLAZING TO BE BY BROSCO OR APPROVED SQUAL.

SAMYN - D'ELIA ARCHITECTS, P.A. P.O. Box 229 Hoklerness, NH 03245 tel: (603) 968-7133

FOR REVIEW OCT, 11, 2023

NOT FOR CONSTRUCTION

HVAC, Elec. & Plumb. Engineer: Charles P. Buckley, P.E. 500 Depot Street Rumney, NH 03266 tel: (603) 786-9992

Structural Engineer: Fisher Engineering, P.C. 686 Belknap Mountain Road Gilford, NH 03249 tel: (603) 528-7641

NH STATE PARKS

Campground Expansion Project PII Mollidgewock State Park 1437 Berlin Road Errol, NH 03579

60% DESIGN

Scale:

Date: Oct. 11, 2023


Drawn By: MR Checked By: WD

Issu	95:	
No.	Description	Date
г		
Т		
г		
Н		
Н		


SCHEDULES

Sheet Number:


A5.01

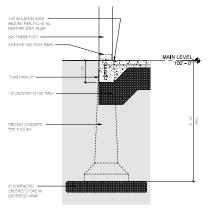

3 SLAB EDGE DETAIL Scale: 3/4" = 1'-0"

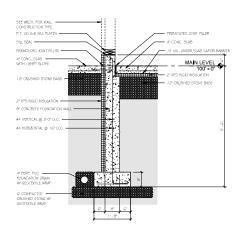

2 TYPICAL FOUNDATION DETAIL
Scale: 3/4" = 1'-0"

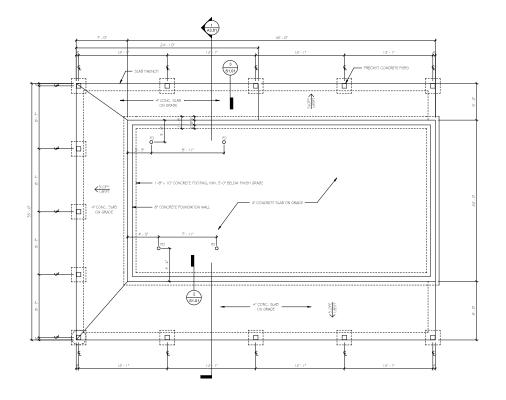

FOUNDATION PLAN
Scale: 1/4" = 1'-0"

SAMYN - D'ELIA ARCHITECTS, P.A.

P.O. Box 229 Holderness, NH 03245 tel: (603) 968-7133

FOR REVIEW
OCT. 11, 2023

NOT FOR CONSTRUCTION

HVAC, Elec. & Plumb, Engineer: Charles P. Buckley, P.E. 500 Depot Street Rumney, NH 03266 tel: (603) 786-9992

Structural Engineer: Fisher Engineering, P.C. 686 Belknap Mountain Road Gilford, NH 03249 tel: (603) 528-7641

NH STATE PARKS

Campground Expansion Project PII Mollidgewock State Park 1437 Berlin Road Errol, NH 03579

sue

60% DESIGN

Grapnic Scale

Scale: As indicated

Date: Oct. 11, 2023

Drawn By: MR

Issues:

No. Description Date

Title

FOUNDATION PLAN

Sheet Number:

S1.01

ect Number: 1923B

SAMYN - D'ELIA ARCHITECTS, P.A.

P.O. Box 229 Holderness, NH 03245 tel: (603) 968-7133

FOR REVIEW

NOT FOR CONSTRUCTION

HVAC, Elec, & Plumb, Engineer: Charles P. Buckley, P.E. 500 Depot Street Rumney, NH 03266 tel: (603) 786-9992

Structural Engineer: Fisher Engineering, P.C. 686 Belknap Mountain Road Gilford, NH 03249 tel: (603) 528-7641

NH STATE PARKS

Campground Expansion Project PII Mollidgewock State Park 1437 Berlin Road Errol, NH 03579

sue

60% DESIGN

Grapnic Scale

orth

Scale: 1/4" = 1'-0"

Date: Oct, 11, 2023

Drawn By: MR

Checked By: JF

Issues		
No.	Description	Date
П		
П		
\Box		
П		
П		
П		

little .

ROOF FRAMING PLAN

Sheet Number:

S2.02

eject Number: 1923B

HVAC NOTES

1. SCOPE OF WORK

- A THE CONTRACTOR IS RESPONSIBLE FOR ALL WORK, MATERIALS, AND LABOR TO SATISFY A COMPLETE WORKING SYSTEM WHETHER SPECIFIED OR IMPLIED.
- B. ALL VORK IS TO BE PERFORMED IN STRICT COMPLIANCE WITH THE INTERNATIONAL MECHANICAL CODE 2018, ALL LOCAL AND ALL OTHER REGULATION GOVERNING WORK OF THIS NATURE.
- C. THE CONTRACTOR SHALL, BETORE SUBMITTING ANY PROPOSAL, EXAMINE THE PROPOSED SITE AND SHALL DETERMINE FOR HINSELT THE CONDITIONS THAT MAY EFFECT THE MORK, NO ALLOWANCE SHALL BE MADE IF THE CONTRACTOR FAILS TO MAKE SUCH EXAMINATION.
- D. ALL EQUIPMENT AND MATERIALS SHALL BE AS SPECIFIED OR "APPROVED EQUAL" BY THE ENGINEER OR ARCHITECT.

2. PERMITS

A. THE CONTRACTOR SHALL SECURE ALL PERMITS OR APPLICA-TIONS AND PAY ANY AND ALL FEES.

SHIP DRAWINGS

A. SUBMIT MATERIAL LIST AND SHOP DRAWINGS FOR MAJOR EQUIPMENT TO THE ACHITECT/ENGINEER FOR APPROVAL. THE CONTRACTOR SHALL SUBMIT FIVE SETS OR SHOP DRAWINGS AND THEY SHALL BE CLEARLY LABELED.

4. DUCTWORK

- A. THE BUCTYORK SHALL BE CONSTRUCTED IN ACCORDANCE WITH THE "SMACNA" APPLICABLE MANUALS, ALL DUCTWORK SHALL BE THE LOW VELOCITY TYPE, UNLESS SPECIFIED OTHERWISE.
- B. CONTRACTOR SHALL PROVIDE AND INSTALL APPROVED FIRE DAMPERS AND ACCESS PANELS IN ANY AND ALL DUCTVORK WHICH PENETRATES A HORIZONTAL OR VERTICAL FIRE PARTI-TION, OR AS OTHERWISE SHOWN ON DRAWINGS.
- C. ALL BRANCH DUCTS TO HAVE VOLUME DAMPERS.
- D. SMOOTH TURN RADIUS DUCTWORK OR TURNING VANES SHALL BE USED THROUGHOUT WHERE FLOW EXCEEDS 150 CFM.
- E. ALL BUCT JOINTS TO BE SEALED IN ACCORDANCE WITH "SMACNA" STANDARDS AND ACCEPTED GOOD PRACTICE.
- F. ALL DUCT DIMENSIONS SHOWN ARE NET INSIDE VALUES. DIMENSIONS MAY BE CHANGED SD LONG AS THE NET FREE FACE AREA IS MAINTAINED.

5. HVAC CONTROLS

A CONTRACTOR TO SUPPLY AND INSTALL ALL CONTROL WIRING AND THERMOSTATS AS REQUIRED.

ELECTRIC

A CONTRACTOR TO COORDINATE WITH ELECTRICAL CONTRACTOR FOR LOCATION OF WIRING FOR EACH HVAC UNIT.

7. MISCELLANEOUS


- A. ALL EXTERIOR OPENINGS TO BE PROPERLY CAULKED AND SEALED WITH A SEALANT OF HIGH QUALITY AND LONG LIFE, TO PREVENT INFILTRATION OF DUTSIDE AIR INTO CONDITIONED SPACE.
- B. DO NOT SCALE THIS DRAWING FOR EXACT DIMENSIONS. VERIFY ALL FIGURES, CONDITIONS, AND DIMENSIONS AT THE JOB SITE.
- C. THE MECHANICAL PLANS ARE INTENDED TO BE DIAGRAMMATIC AND ARE BASED ON DOE MANUFACTURE'S EQUIPMENT. THEY ARE RIGHT INTENDED TO SHAPE VERY TEMPLATED BY THE ALL THE DETAILS OF THE EQUIPMENT. THE CONTRACTOR SHALL VERBY THE ACTUAL DIMENSIONS OF THE COUPMENT PROPOSED TO ENSURE THAT THE EQUIPMENT WILL STANDARD AVAILABLE SPINE.

8. TESTING AND BALANCING

A. THE HVAC SYSTEM SHALL BE TESTED AND AND BALANCED BY AN INDEPENDENT AGENCY, NOBER THE SUPER-VISION OF A LICENSED PROFESSIONAL ENGINEER. A SEALED TYPE WRITTEN REPORT SHALL BE SUBMITTED TO THE ARCHITECTHORIBER FOR REVIEW AND APPROVAL.

9. GUARANTEE

- A MATERIALS, EQUIPMENT AND INSTALLATION SHALL BE GUARANTEED FOR A PERIOD OF DIME() YEAR FROM DATE OF ACCEPTANCE, DEFECTS WHICH APPEAR DURING HIT PERIOD SHALL BE CORRECTED AT THIS CONTRACTOR'S FYSPING
- B. FOR THE SAME PERIOD, THE MECHANICAL CONTRACTOR SHALL BE RESPONSIBLE FOR ANY DAMAGE TO PREMISES CAUSED BY DEFECTS IN VIORKMANDHIP DR IN THE VIDEK OR EQUIPMENT FURNISHED AND/OR INSTALLED BY HIM.

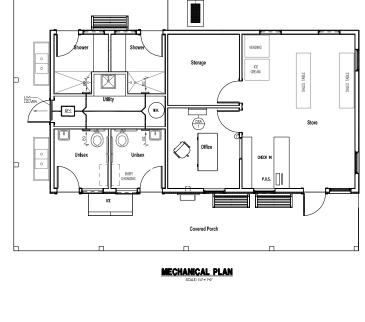

			FAN S	CHEDU	JLE		
SERVICE	LOCATION	CFM	STATIC PRESS.	MOTOR			MANUFACTURE & MODEL
			(IN. W.G.)	HP	RPM	VOLT-PHASE	

1/6 1800 115-1

GREENHECK SQ-80-VG

			DUC	ΓLE	ESS	SPLI	ΓΑΙΙ	R CO	NC	TIC	IONING	SYSTEM SCH	IEDULE (DSA)
INDOOR UNIT	OUTDOOR UNIT		HEATING CAPACITY (BTU/HR.)			SEER-COP (EFFICIENCY)	PIE	ERANT ING SUCTION	MCA		VOLTPHCY.	MANUFACTURER & MODEL	OPTIONS-ACCESSORIES
	DSHP-1	12,000	13,500			19 - 3.6	1/4"	3/8"	11	15	240/1/60	MITSUBISH WODEL PUZ-A12NKA7	CONDENSATE PUMP
DSA-1		12,000	13,500	340			1/4"	3/8"	1.1	15	240/1/50	M[TSUB[SH] WODEL PKA-A12HA7	MRELESS THERMOSTAT (BY MITSUBISH) NOCOR HP UNITTO HAVE DISCONNECT.

0.625

EF-1 TOILETS RM.-SHOWERS CHASE 200

CHARLES P. BUCKLEY PROFESSIONAL ENGINEER PROFESSIONAL ENGINEER PROFESSIONAL ENGINEER TAX (000)780 - 00000 TXX (000)780 - 00000

N.H. LIC. NO. 09198

HVAC, Elec. & Plumb. Engineer: Charles P. Buckley, P.E. 500 Depot Street Rumney, NH 03266 tel: (603) 786–9992

Structural Engineer: Fisher Engineering, P.C. 686 Belknap Mountain Road Gilford, NH 03249 tel: (603) 528-7641

NH STATE PARKS

Campground Expansion Project PII Mollidgewock State Park 1437 Berlin Road Errol, NH 03579

Issue

60% DESIGN

Graphic Scale

h

Scale: As indicated

Date: Oct. 11, 2023

Drawn By: CPB

Checked By: CPB

No.	Description	Date

Title


MECHANICAL PLAN AND DETAILS

Sheet Number:

M1.01M

Project Number: 23045001

File:

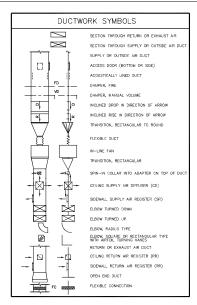

ELECTRICAL NOTES

- 1. SCOPE OF WORK:
- A. CONTRACTOR SHALL VISIT SITE PRIOR TO BIDDING. BIDS SHALL SERVE AS EVIDENCE OF KNOWLEDGE OF EXISTING CONDITIONS. FIELD VERIFY ALL ELECTRICAL EQUIPMENT.
- B. FURNISH ALL LABOR, MATERIALS, EQUIPMENT AND TOOLS TO PERFORM ELECTRICAL WORK SHOWN, NOTED OR SCHEDULED FOR A COMPLETE AND FINISHED INSTALLATION.
- MATERIAS, PRODUCTS AND EQUIPMENT, INCLUDING ALL COMPONENTS THREEOF, SHALL BE NEW AND SUCH AS APPEAR ON THE UNDERWRITERS LAGORATORES LIST OF APPROVAD LIBES AND SHALL BE SZED IN CONFORMITY WITH REQUIRMENTS OF THE NATIONAL ELECTRICAL CODE AND OTHER APPLICABLE CODES, WHICHEVER ARE MORE STRINGENT.
- C. ALL WORK TO BE IN ACCORDANCE WITH 2020 NEC AND ALL APPLICABLE FEDERAL, STATE LOCAL CODES.

2. PERMITS:

A. SECURE AND PAY FOR ALL REQUIRED PERMITS AND INSPECTION CERTIFICATES.

A. SUBMIT MATERIAL LIST AND SHOP DRAWINGS FOR MAJOR EQUIPMENT TO THE ARCHITECT FOR APPROVAL. SUBMITTALS SHALL BE IN ACCORDANCE WITH GENERAL CONDITIONS AND SHALL BEAR STAMP OF THE GENERAL CONTRACTOR SHOWN THAT HE HAS REVENED AND APPROVAD THEM. LAKE OF SUCH CONTRACTOR'S APPROVAL WILL BE CAUSE FOR REACTION WITHOUT REVEN BY THE ARCHITECT OR ENGINEER.

4. CONDUITS:

A. THE TYPE OF CONDUIT SHALL BE AS FOLLOWS FOR ALL FEEDERS AND DISTRIBUTION

CIRCUITS, UNLESS OTHERWISE SPECIFIED.	
APPLICATION OUTDORS BRANCH CIRCUITS (EXPOSED) BRANCH CIRCUITS (CONCEALED) SUPPLY TO DISTRIBUTION PANEL UNDERGROUND SERVICE ENTRANCE	TYPE OF CONDUIT GALV. RIGID STEEL OR EMT W/ W.P. FITTINGS EMT MC EMT PVC = SCHEDULE 40

WIRE:

- A. WIRE SHALL BE SINGLE CONDUCTOR COPPER WITH 600 VOLT INSULATION. MINIMUM WIRE SIZE SHALL BE #12 EXCEPT #14 MAY BE USED FOR CONTROL. ALL WIRE AND CABLE SHALL BE NEW AND SHALL BE BROUGHT TO THE SITE IN UNRORKEN PACKAGES.
- . GENERAL WIRING SHALL BE THW OR THHN (ALUMINUM CONDUCTORS ARE NOT PERMITTED).
- B. WIRE CONNECTORS SHALL BE EQUAL BY SCOTCHLOCK FOR #6 AND SMALLER AND T & B "LOCK-LITE" FOR #6 AND LARGER.

6. LIGHTING:

A. LIGHTING FIXTURES AND LAMPS (UNLESS NOTED OTHERWISE) SHALL BE FURNISHED BY THE ELECTRICAL CONTRACTOR. ELECTRICAL CONTRACTOR SHALL INSTALL ALL FIXTURES AND LAMPS.

- A. RECEPTACLES SHALL BE 20 AMP, 3-WIRE GROUNDING TYPE EQUAL TO HUBBELL 5362 (MOUNTING @ 18*A.F.F.).
- B. SWITCHES SHALL BE STANDARD GRADE RATED 20 AMP AT 120 VOLT (MOUNTING @48*A.F.F.)
- C. SPECIAL DEVICES SHALL BE A SPECIFICATION GRADE.

8. SAFETY SWITCHES:

PROVIDE SAFETY AND DISCONNECT SWITCHES, FUSED OR NONFUSED, AS CALLED FOR ON DRAWNINGS AND AS REQUIRED BY CODE. SWITCHES SHALL BE HEAVY DUTY, LOAD AND HORSEPOWER PATED AS MANUFACTURED BY SCUARE D, SCULD, ITE OR ECULA.

- A. OUTLET BOXES AND COVERS SHALL BE GALVANIZED, ONE—PIECE PRESSED STEEL KNOCKOUT.
- B. JUNCTION, PULL BOXES AND COVERS SHALL BE GALVANIZED STEEL, CODE GAUGE SIZE.

- HISTALATION.

 A LL ELGTRICAL WORK SHALL BE INSTALLED SO AS TO BE READLY ACCESSIBLE FOR OFERATING, SERVICING, MAINTAINNO AND REPLANNE. HANGERS SHALL INCLUDE ALL OFFICE AT THE ACCESSIBLE FOR OFFICE AND ALL OFFICE ALL BE FASTELED TO STEEL, CONDUCTOR OF WORK AND SHALL BE FASTELED TO STEEL, CONDUCTOR SHALL BE IN STRUCKLED WHEREVER POSSIBLE. DAYOUT SHALL BE IN STRUCKLED WHEREVER POSSIBLE SHALL SHIP OF A STRUCKLED SHALL BE IN CORDUIT DUTTE OF A PROPOSED MERCENA'S IN CONDUCTOR'S SHALL BE IN COUNTRY OF A STRUCKLED MERCENA'S IN STRUCKLED SHALL SHIP OF A STRUCKLED SHALL BE IN CONTRY OF A STRUCKLED SHALL BE IN A STRUCKLED SHALL BE SHALLD AFTER CONDUIT INSTALLATION TO REMAIN THEM THE ARTHMAN AND A STRUCKLED SHALL BE SHALLD AFTER CONDUIT INSTALLATION TO REMAIN THEM THE ARTHMAN AND A STRUCKLED SHALL BE SHALLD AFTER CONDUIT INSTALLATION TO REMAIN THEM THE ARTHMAN AND A STRUCKLED SHALL BE SHALLD AFTER CONDUIT INSTALLATION TO REMAIN THEM THE ARTHMAN AND A STRUCKLED SHALL BE SHALLD AFTER CONDUIT INSTALLATION TO

- C. HHE FOLLOWIN COURTENT SHALL BE IDENTIFIED WITH ENGRAYED BAKELITE NAMEPLATES AS TO NAME AND/OF FUNCTION, DISTRIBUTION PARELS AND DISCONNECT SWITCHES.

 IN THE LOCATION OF CULTER'S MOD CUMPARENT SHOWN ON THE DRAWNING ARE APPROXIMATE AND THE ARCHITECT SHALL HAVE THE RIGHT TO RELOCATE ANY OUTLETS OR TIXTURES BEFORE THEY ARE INSTALLED WITHOUT ADDITIONAL COST.
- E. ELECTRICAL CONTRACTOR SHALL RECORD ALL FIELD CHANGES IN HIS WORK AS THE JOB PROGRESSES.

- A. MATERIALS, EQUIPMENT AND INSTALLATION SHALL BE GUARANTEED FOR A PERIOD OF ONE (1) YEAR FROM DATE OF ACCEPTANCE. DEFECTS WHICH APPEAR DURING THAT PERIOD SHALL BE CORRECTED AT THIS CONTRACTOR'S EXPENSE.
- B. FOR THE SAME PERIOD, THE ELECTRICAL CONTRACTOR SHALL BE RESPONSIBLE FOR ANY DAMAGE TO PREMISES CAUSED BY DEFECTS IN WORKMANSHIP OR IN THE WORK OR EQUIPMENT FURNISHED AND/OR INSTALLED BY HOS

12. FINALLY:

A. IT IS THE INTENT THAT THE FOREGOING WORK SHALL BE COMPLETE IN EVERY RESPECT AND THAT ANY MATERIAL OR WORK NOT SPECIFICALLY MENTIONED OR SHOWN ON THE DRAWINGS, BUT NECESSARY TO FULLY COMPLETE THE WORK SHALL BE FURNISHED.

ELECTRICAL SYMBOLS

ABBREVIATIONS

ABOVE COUNTER
ABOVE COUNTER
ABOVE COUNTER
ABOVE FINISHED FLOOR
CIRCUIT BREAKER
EXPLOSION PROOF.
GROUND FAULT CIRCUIT INTERRUPTER.
GROUND FAULT CIRCUIT INTERRUPTER.
GROUND FAULT
LIGHTING PANEL.
MOTOR CONTROL. CENTER.
MOUNTING FEIGHT, MANHOLE.

NATIONAL ELECTRICAL CODE.

NATIONAL ELECTRICAL MANUFACTURERS ASSOC.

NOT IN CONTRACT. NIGHT LIGHT. PHOTOELECTRIC SWITCH

POWER PANEL RECEPTACLE PANEL. UNDERGROUND. UNLESS OTHERWISE NOTED. WEATHER PROOF.

WIRING

WIRING CONCEALED IN CEILING OR WALLS; SLASH MARKS INDICATE NUMBER OF CONDUCTORS EXCLUDING GROUNDS; CONDUCTOR SIZE AS MARKED; #12 AWG UON.

UNDERGROUND CABLE OR DUCT; TYPE, SIZE, CONDUCTORS, AND ARRANGEMENT BY NOTATION OR SCHEDULE.

WIRING RUN EXPOSED.

SWITCH OUTLET: MOUNTED 48° AFF UCN; SINGLE POLE UCN; LOWER CASE LETTER, WHEN PRESENT, INDICATES OUTLETS CONTROLLED: ABBREVIATIONS FOR SWITCH OUTLETS

- DOUBLE POLE SWITCH 4-WAY SWITCH KEY OPERATED SWITCH DOOR SWITCH
- D DIMMER SWITCH: MOUNTED 48" AFF UON; LOWER CASE LETTER, WHEN PRESENT, INDICATES OUTLETS CONTROLLED.

LIGHTING

0

FLUORESCENT LIGHT FIXTURE - RECESSED, SURFACE, OR PENDENT MOUNTED

 Θ \circ RECESSED MOUNTED CEILING FIXTURE

ф-

SURFACE MOUNTED CEILING FIXTURE

ЮΜ

INCANDESCENT FIXTURE, WALL

◙

SURFACE OR PENDANT MOUNT EXIT SIGN FIXTURE; ARROWS INDICATE REQUIRED SIGN ARROWS.

BATTERY POWERED EMERGENCY LIGHTING FIXTURE

E E

COMBINATION EMERGENCY LIGHTING FIXTURE AND EXIT SIGN

Α

INDICATES FIXTURE TYPE: SEE SCHEDULE.



GROUNDED DUPLEX RECEPTACLE (NEMA 5-20R); MOUNTED 18" AFF UON; NUMBER INDICATES CIRCUIT.

#

GROUNDED QUADRUPLEX RECEPTACLE (NEMA 5-20R); MOUNTED 18" AFF UON.

•

SPECIAL PURPOSE RECEPTACLE; LETTER INDICATES TYPE; TYPE DEFINED BY NOTATION OR SCHEDULE; MOUNTED 18" AFF UON.

PANELS AND MISC.

□H_{FSS}

FUSED SAFETY (DISCONNECT) SWITCH

LIGHT OR POWER PANEL

□H_{NFSS}

NON-FUSED SAFETY (DISCONNECT) SWITCH

J

6

TELEPHONE OUTLET - WALL - MOUNTED 18" AFF, UON PROVIDE 4X4 OUTLET BOX IN WALL WITH 3/4" CONDUIT TO ABOVE CEILING WITH PULL WIRE, WIRING BY OTHERS.


Δ

COMPUTER OUTLET - WALL - MOUNTED 18" AFF UCN. PROVIDE 4X4 OUTLET BOX IN WALL WITH 3/4" CONDUIT TO ABOVE CEILING WITH PULL WIRE. WIRING BY OTHERS

ELECTRICAL NOTES

- VERIFY CONDITION AND CAPACITY OF EXISTING ELECTRICAL SERVICE

- CERT CONTROL AND OPENIOR AND OPENIOR ELECTROCY SERVICE (MINIMAN 100 ARE SERVICE). REDUCED AN BETWELK AS EQUILIBRY INFORMED AND CONTROL AND AND

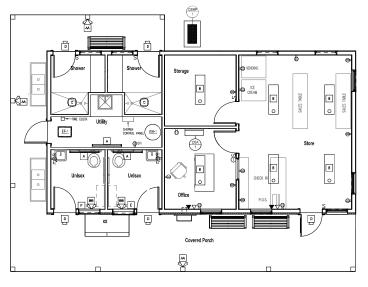

ELECTRICAL POWER PLAN

LIGHT	NG FIXTURE SCH	EDULE		
WAK	MANUFACTURER	FIXTURE MAKE/MODEL	LAMPING	MOUNTING
A	METALUX	4-BCLED-LD4-28SL-F-UNV-L830-CD-1	32W LED	WALL MOUNTED @ 8'-0" AFF
В	METALUX	4WSNLED-LD4-40SL-UNV-L840-CD1-U	39W LED	CEILING MOUNTED - SURFACE
C	HALO	SLD606-8-30-WH	12.5W LED	CEILING MOUNTED
D	RAB	BRISKS17L-730	14W LED	ABOVE DOOR/BEHIND BEAN/POST
E	LEGRAND	TMHWLECC	1/4W LED	MOUNT 24" AFF
A	DUAL-LITE	LZRDB0605	2-5W/NR16	MOUNT TOP 6" T.O. WALL
88	DUAL-LITE	LZ2501 (25 WATT BATTERY)	2-5W/MR16	MOUNT TOP 6" BELOW CEILING

CLIPIE CHARLES P. BUCKLEY

N.H. LIC. NO. 09198

HVAC, Elec. & Plumb, Engineer: Charles P. Buckley, P.E. 500 Depot Street Rumney, NH 03266 tel: (603) 786-9992

Structural Engineer: Fisher Engineering, P.C. 686 Belknap Mountain Road Gilford, NH 03249 tel: (603) 528-7641

NH STATE PARKS

Campground Expansion Project PII Mollidgewock State Park 1437 Berlin Road Errol, NH 03579

Issue

60% DESIGN

Graphic Scale

North

Scale: As indicated

Date: Oct. 11, 2023

Drawn By: CPB

Description

ELECTRICAL PLAN AND DETAILS

E1.01M

Project Number: 23045001

			W	ATER	HEATE	R SCI	EDULE		
WARK	CAPACITY	RECOVERY 0	BTU PER HR.	GAS CONN.	WATER CONN.	ELECTRIC		MANUFACTURE & MODEL	REMARKS
		100 DEG. F. RISE		CONN.	OUNN.	AMPS	VOLT-PHASE	a water	
WH-1	60 GAL.	138 GAL,/HR.	120,000	3/4*	1-1/4"	10.0	120-1	A.O. SMITH MODEL BTH 120	-PROPAME FIRED -POWER VENTED -4" VENT & COMB. AIR PIPES -140 DEG F. DISCHARGE TEMP.

PLUMBING NOTES

SCOPE OF WORK

- A. THE CONTRACTOR IS RESPONSIBLE FOR ALL WORK, MATERIALS, AND LABOR TO SATISFY A COMPLETE WORKING SYSTEM WHETHER SPECIFIED OR IMPLIED.
- B. ALL WORK IS TO BE PERFORMED IN STRICT COMPLIANCE WITH THE INTERNATIONAL PLUMBING CODE (2018).
- C. THE CUNTRACTOR SHALL, BEFORE SUBMITTING ANY PROPOSAL, EXAMBLE THE PROPOSED SITE AND SHALL DETERMINE FOR HIMSELF THE CONDITIONS THAT MAY EFFECT THE VORK, NO ALLOWANCE SHALL BE MADE IF THE CONTRACTOR FAILS TO MAKE SUCH EXAMINATIONS.
- B. ALL EQUIPMENT AND MATERIALS SHALL BE AS SPECIFIED OR "APPROVED EQUAL" BY ENGINEER OR ARCHITECT.

SHIP DRAWINGS

- A. SUBMIT MATERIAL LIST AND SHOP DRAVINGS FOR MAJOR EQUIPMENT/FIXTURES TO THE ARCHITECT OR ENGINEER FOR APPROVAL THE SHOP DRAVINGS SHALL BE CLEARLY TAGGED AND HIGHLIGHTED.
- DOMESTIC WATER SUPPLY PIPING
- A. ABOVE GROUND MAINS AND BRANCHES COPPER PIPE WITH SOLDER JOINTS. BRANCHES PEX VITH PEX FITTINGS.
- B. ALL HOT WATER PIPING TO BE INSULATED WITH 1' FIBERGLASS INSULATION.
- C. ALL COLD WATER PIPING TO BE INSULATED WITH 1/2' FOAM INSULATION.
- D. PROVIDE DOMESTIC WATER SHUT-OFFS AT EACH PLUMBING FIXTURE.

4. SANITARY/STORM DRAINAGE AND VENT PIPING

- A. ABDVE GRADE:
 -2' AND BELDW SCH. 40 PVC WITH SOLVENT JOINTS. -3" AND ARRIVE SCH. 40 PVC WITH SOLVENT JOINTS.
- B. BELOW GRADEISCH, 40 PVC WITH SOLVENT JOINTS.
- C. PVC PIPING SHALL NOT BE USED IN AIR PLENUM CEILINGS AND SHALL NOT CROSS FIRE RATED WALLS, CEILINGS, DR FLODRS. D. DRAINAGE PIPING SHALL BE RUN AS STRAIGHT AS POSSIBLE AND SHALL HAVE LONG TURN FITTINGS.
- E. DRAINAGE PIPING 3' SIZE AND SMALLER SHALL RUN AT A UNIFORM GRADE OF AT LEAST 1/4' PER FOOT, AND PIPING LARGER THAN 3" SHALL BE RUN AT A GRADE OF NO LESS THAN 1/8' PER FOOT.
- F. CONTRACTOR SHALL BE RESPONSIBLE FOR THE PROPER FLASHING OF THE VENT PIPING RUN THROUGH THE ROOF.
- ALL STUB-INS AND/OR SLAB OR WALL PENETRATION TO BE PER INTERNATIONAL PLUMBING CODE. ALL PIPING PENETRATIONS OF BUILDING FOUNDATIONS, FOOTINGS AND WALLS SHALL BE SLEEVED.
- 6. PIPE SUPPORTS


PLUMBING CODE.

A ABUVE GRADE
ALL PIPE SHALL BE SUPPORTED FROM THE BUILDING
STRUCTURE. IN A NEAT AND WORKMANLIKE MANNER.
THE USE OF WIRE, AND PERFORMED METAL TO SUPPORT
PIPES WILL NOT BE PERMITTED. SPACING OF PIPE SUPPORTS.
SHALL BE AS SPECIFIED IN THE INTERNATIONAL.

7. MISCELLANEOUS

- A COORDINATE INSTALLATION OF ALL ROOF FLASHING AT ROOF PENETRATION.
- B. DU NOT SCALE THIS DRAVING FOR EXACT DIMENSIONS. VERIFY ALL FIGURES, CONDITIONS, AND DIMENSIONS AT THE JOB SITE.
- C. THE PLUMBING PLANS ARE INTENDED TO BE DIAGRAMATIC AND ARE BASED ON DISK MANUA ACTIONER'S EQUIPMENT OF A STATE OF THE PLANS OF THE PL
- D. SEAL AND FLASH ALL WALL PENETRATIONS AIR AND WEATHER-TIGHT.
- 8. TESTING AND DISINFECTION
- A PLUMBING SYSTEMS SHALL BE FLOW AND PRESSURE TESTED & DISINFECTED IN ACCORDANCE WITH STANDARD PRACTICE AND THE INTERNATIONAL PLUMBING CODE.

PLUMBING SYMBOLS SYMBOL DESCRIPTION SYMBOL DESCRIPTION ---- SOIL OR WASTE PIPE (BELOW GROUND) SOIL OR WASTE PIPE (ABOVE GROUND) 0 PRESSURE CACE ----- VENT PIPE (V) TEMPERATURE GAGE ----- COLD WATER PIPE (CW) —Æ— PRESSURE REDUCING VALVE ----- HOT WATER PIPE (HW) -\$-GAS COCK - HOT WATER RETURN (HWR) GAS PIPE LAVATORY S D.——— STORM DRAIN WATER CLOSET **—**□ FD URINAL —0 □ CLEAN-OUT(FLOOR) COLD WATER CONNECTION -1 00 CLEAN-OUT(WALL OR ABOVE CLG.) **∢** (120°F) (VH) HOT WATER HEATER **₫** (140*F) HOT WATER CONNECTION $-\!\!\bowtie\!\!-$ GATE VALVE HOT WATER RETURN CONNECTION $-\sqrt{\lambda}$ GAS CONNECTION \$1− TEMP. /PRESS. RELIEF VALVE C.S. FIXTURE ISOLATION VALVE GV ELECTRIC GAS VALVE FOR PIPING UNDER HOODS — TIE INTO ANSUL SYSTEM -10√0-BALL VALVE

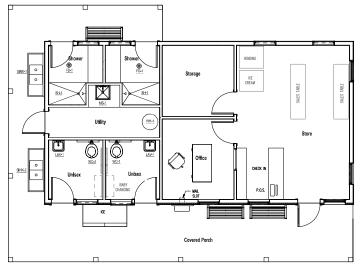

PLUMBING PLAN

		PLUME		
WARK	DESCRIPTION	MANUFACTURER - MODEL #	ACCESSORIES & NOTES	COLOR & FINISH
WC-1	ACCESSIBLE TOILET	AMERICAN STANDARD: AFWALL MILLENUM FLOWISE 1.28 GPF FLUSHOMETER MODEL: 2856.128	FILUSH WAVE: AMERICAN STANDARD MODEL 6047.121.002 TOLLET SEAT: AMERICAN STANDARD MODEL 45901.100 CARREN:	WHITE
LW-1	COUNTER SINK	CORIAN: ADA-COMPLIANT MCDEL #810	FULCET: STIMUCHS STIMUCHS S-20-2-0.5, TRUP: CHROME PLATED, MILING VALVE: STIMUCHS MAXIJINE 7-210-OK-W, PIPE COVERS: TRUEBRO LAV CUMBO 2 E-2 SERIES	MS SELECTED BY ARCHITECT
SH-1	ACCESSIBLE SHOWER	CUSTOM	DRVIN: WATTS FD-1100-4-2-MH-45-7, HEAD: SYMMONS SAFETYMIX 4-151 (2 HEADS © ADA), CONTROLS: SYMMONS SAFETYMIX 4-500-BX-1P, DMERTER WALVE: SYMMONS MODEL 2DM, COIN-OP: FILLID MANUFACTIVENES COIN OPERATED CONTROL: WALVE SYSTEM.	AS SELECTED BY ARCHITECT
FD-1	FLOOR DRAIN	ZURN: MODEL FD2-TSP-VP	TRAP PRIMER: PRECISION PLUMBING PRODUCTS PR-500	
MS-1	MOP SINK	TINI MODEL MODETET	FAUCET: FIAT MODEL 830AA MOP HANGER: RIA MODEL889CC FIAT STANKESS BUMPER GUARD	
SINK-1	DISH WASHING SINK	ADVANCE TABCO MODEL WCT-246 WITH TA-11a-2 BOWLS AND ADJUSTABLE LEGS MOUNTED AT ACCESSIBLE HEIGHT (MOUNTED AT BARRIER-FREE HEIGHT).	FAUCET: ADVANCE TABCO HEAVY DUTY MODEL K-1118 SPASH MOUNTED FAUCETS, 8" CTRS., SMING NOZZE, 12" SPOUT. STANLESS STEEL STRANKER AND DRAIN BODY. - FROMIDE 1 FAUCET PER EACH BOWL.	
SINK-2	DISH WASHING SINK	ADVANCE TABCO MODEL VKCT-246 WITH TA-11B-2 BOWLS AND ADJUSTABLE LEGS.	FAUCET: ADVANCE TABCO HEAVY DUTY MODEL K-1118 SPASH MOUNTED FAUCETS, 8" CTRS., SHING NOZZLE, 12" SPOUT. STANLESS STEEL STRANGE AND DEANN BODY. FROMED F FAUCET FREE ACID BOML.	

WITES 1 SOMEDULE MODIFIES PROTURES SELECTED AS THE BASIS OF DESIGN, ALTERNATIVES WILL BE ACCEPTED 3 WHER PRIVE SHALL BE NOTIFIED TO ALLOW FOR SEASONAL DRAW DOWN OF THE WATER SYSTEM.

F EQUAL OR BETTER QUALITY.

WHERE PRIVE SHAN WAVES AS REQUIRED AT LOW POINTS. DRAW WAVES SHALL BE LOCKED TO LIMIT FURLE.

ACCESS (2) PROVIDE ALL NECESSARY TRIM AND FITTINGS REQUIRED FOR A COMPLETE INSTALLATION

CUPIE CHARLES P. BUCKLEY
PROFESSIONAL ENGINEER

N.H. LIC. NO. 09198

HVAC, Elec. & Plumb. Engineer: Charles P. Buckley, P.E. 500 Depot Street Rumney, NH 03266 tel: (603) 786-9992

Structural Engineer: Fisher Engineering, P.C. 686 Belknap Mountain Road Gilford, NH 03249 tel: (603) 528-7641

NH STATE PARKS

Campground Expansion Project PII Mollidgewock State Park 1437 Berlin Road Errol, NH 03579

_	
\dashv	Issue
┪	60% DESIGN
	Graphic Scale
	North
\dashv	Notes
	-
4	Scale: As Indicated
┨	Date: Oct. 11, 2023
	Drawn By; CPB
4	G1
	Checked By: CPB
	Issues:

No.	Description	Date
_		
+		
+		
+		

Title

PLUMBING PLAN AND DETAILS

P1.01M

Project Number: 23045001