



Division of Parks and Recreation New Hampshire
Department of Resources
and

Economic Development

Division of Public Works, **Design and Construction**

New Hampshire Department of Administrative Services

Civil Engineer / Landscape Architect / Surveyor



SAMYN - D'ELIA ARCHITECTS, P.A (603) 968-7133 / fax: (603) 968-3057 sdarchitects.com

Foley Buhl Roberts
& ASSOCIATES INC

F 603-622-4593 www.fbra.com Manchester NH 03101



Drawing Set Log Revision Date Appvd.

CAD checked b Scale AS NOTED

Project Title and Location

Jenness Bathhouse Replacement and Parking Lot Improvements 2280 Ocean Boulevard Rye, New Hampshire 03870

Issued for


Construction Documents Issued: June 30, 2016


Project Number **NHBPW** - 80877B VHB -52348.05

SDA -1535

Drawing Title

Building Sections

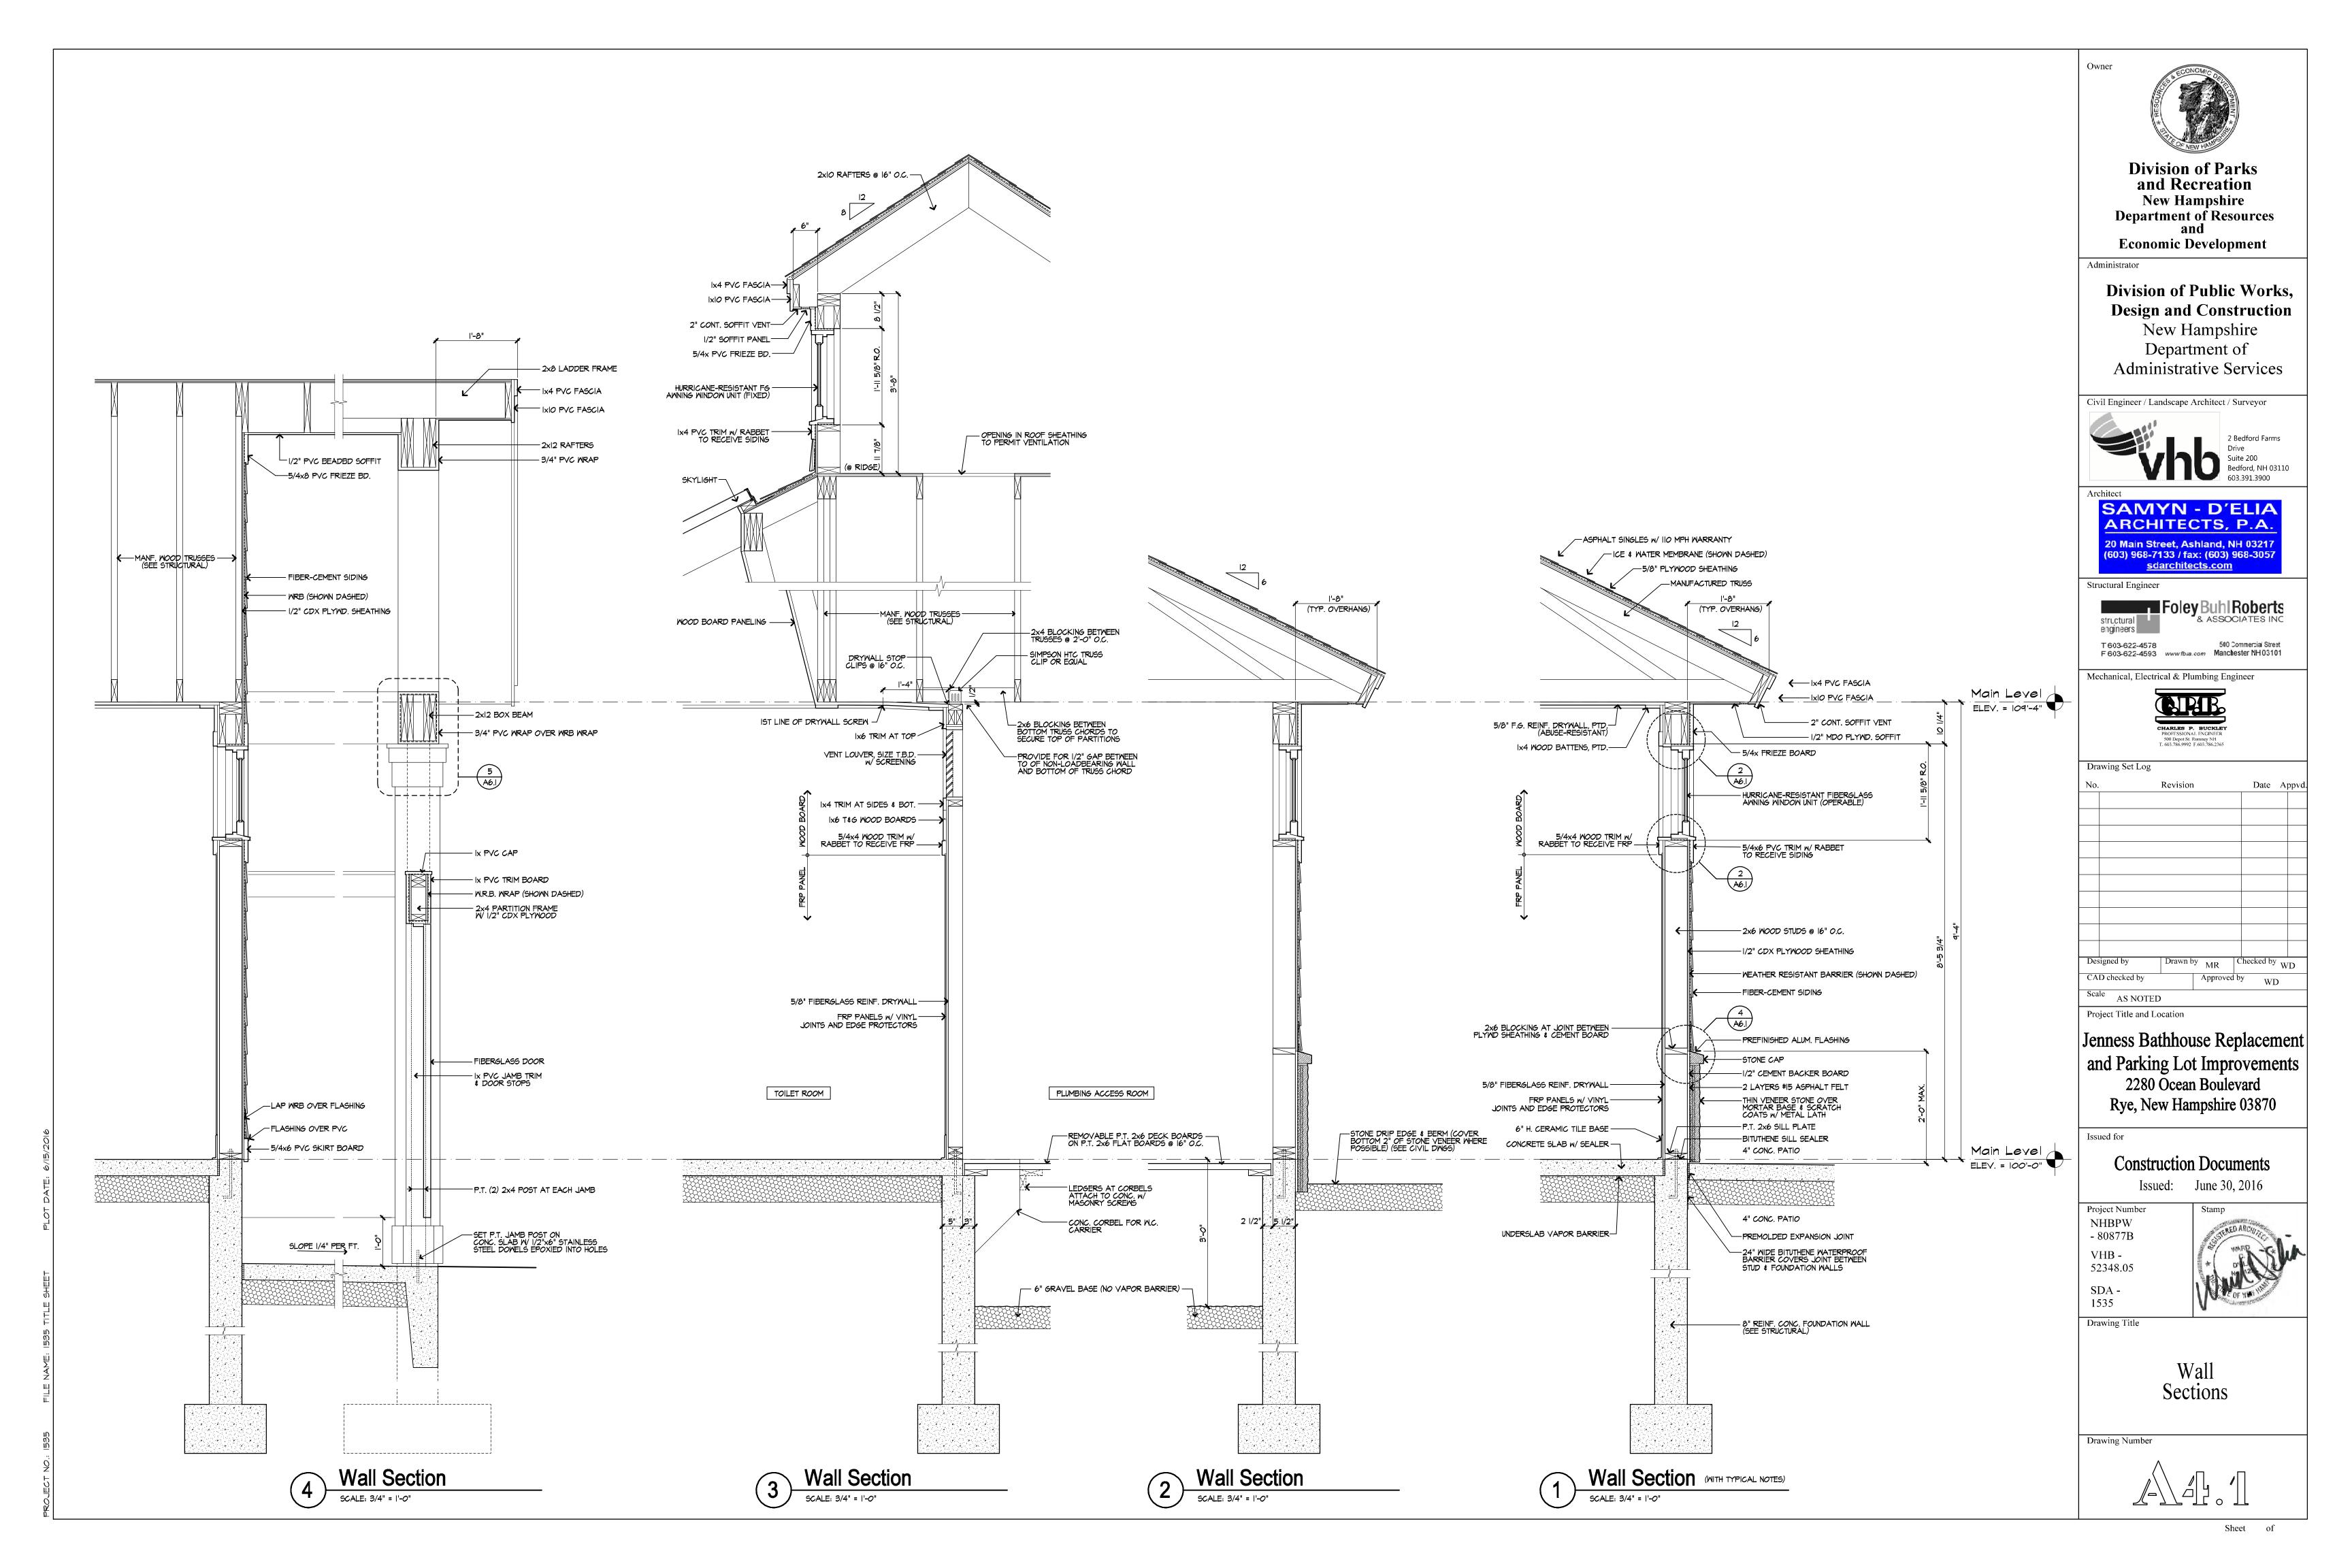

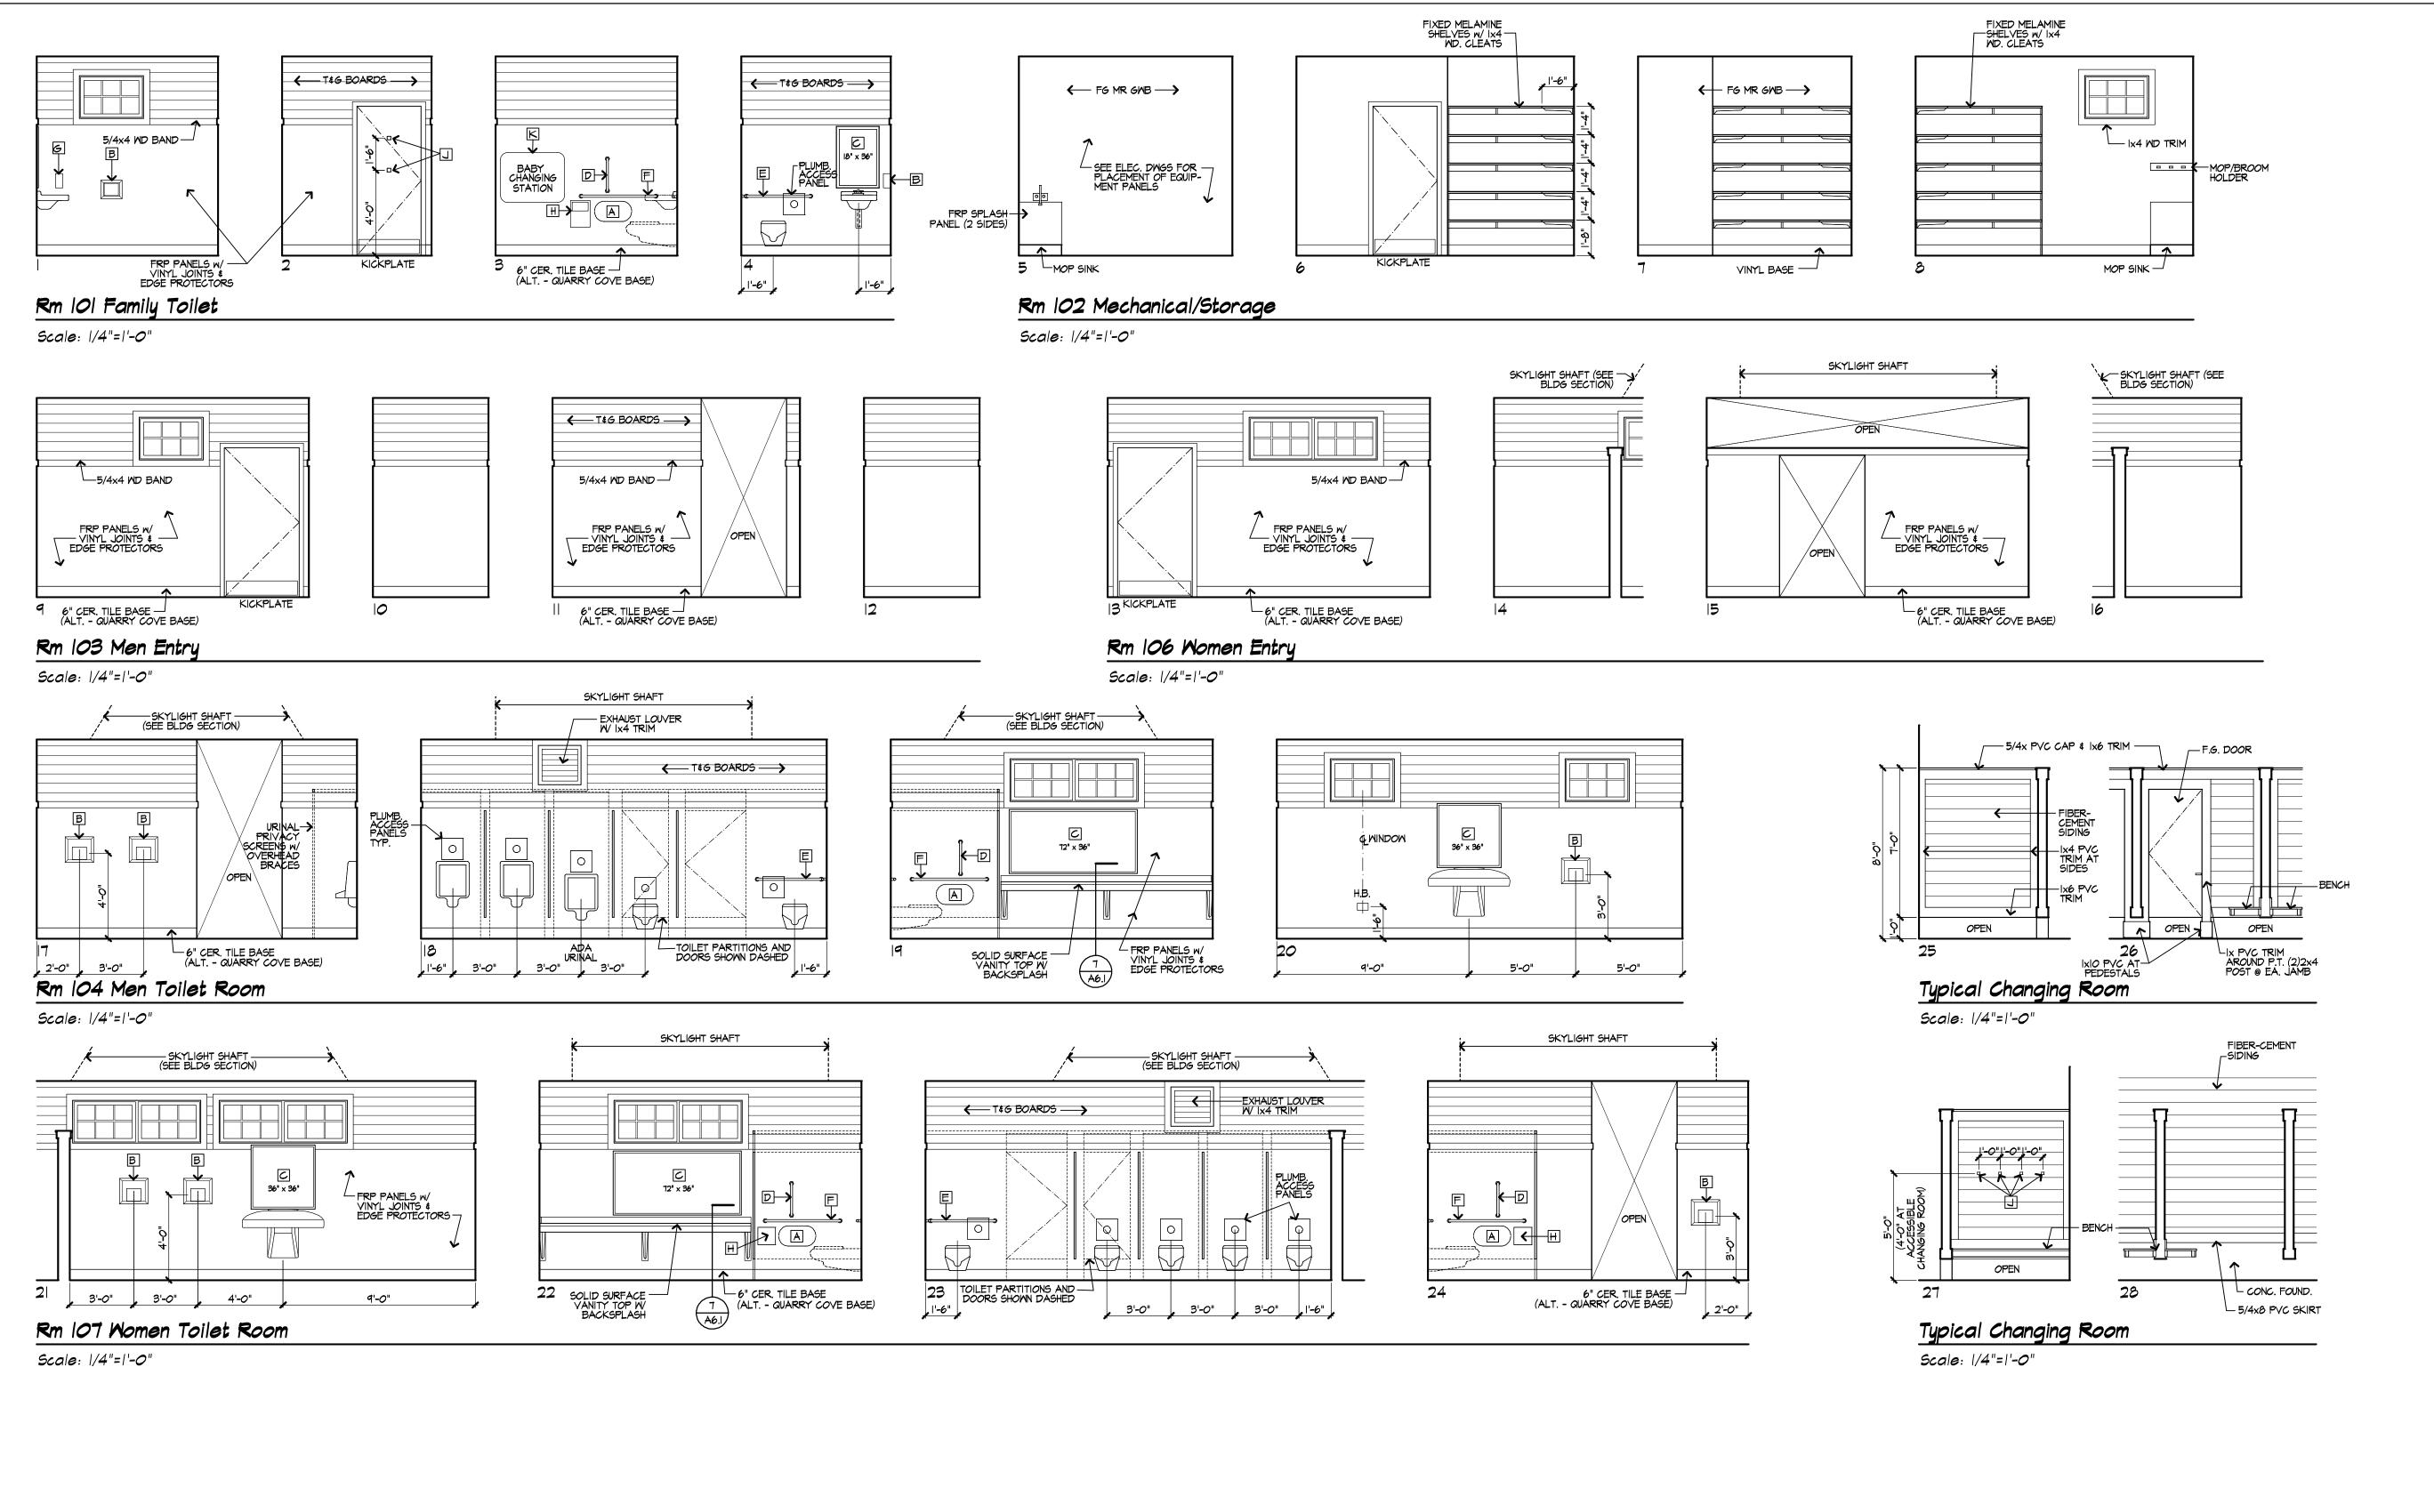

REGULAR MOUNTING HEIGHTS ADA MOUNTING HEIGH

Typical Locations and Mounting Heights

NOTE I PROVIDE BLOCKING BEHIND WALL FINISH AS REQUIRED FOR SECURE MOUNTING OF GRAB BARS, TOWEL BARS, ROBE HOOKS, ETC. NOTE 2: PROVIDE INSULATED PVC PROTECTION OVER EXPOSED PLUMBING LINES. (ONLY IF SKIRTBOARD IS NOT INSTALLED)

NOTE 2: PROVIDE INSULATED PVC PROTECTION NOTE 3: DIMENSIONS ARE TO FINISH SURFACES.

TOILET ACCESSORY SCHEDULE KEY DESCRIPTION MANUFACTURER MODEL NO. REMARKS TOILET PAPER HOLDER DOUBLE-ROLL TYPE MOUNTED ON SIDE PARTITION BOBRICK B-2892 VANDAL-PROOF RECESSED MODEL ELECTRIC HAND DRYER ASI 0133 MIRROR UNIT BOBRICK B-290 SEE INT. ELEVS FOR SIZES 18" GRAB BAR, VERTICAL BOBRICK B-6806.99x18 36" GRAB BAR, HORIZONTAL BOBRICK B-6806.99x36 BOBRICK B-6806.99×42 42" GRAB BAR, HORIZONTAL BOBRICK WALL-MOUNTED MODEL NAPKIN/TAMPON DISPOSAL BOBRICK B-254 (2) HOOKS ON BACK OF EACH DOOR TO WC STALL (4) HOOKS ON WALL ABOVE BENCH IN CHANGING ROOM BOBRICK B-6717 BABY CHANGING STATION KOALA KB-200-00 HORIZONTAL, MICROBAN POLYETHYLENE MOP AND BROOM HOLDER BOBRICK B-223x24

NOTES:

I. MOUNT TOILET PAPER HOLDER & NAPKIN DISPENSER ON THE PARTITION AT THE HINGE SIDE OF DOOR.



Division of Parks and Recreation New Hampshire Department of Resources and

Economic Development

Administrator

Division of Public Works, Design and Construction

New Hampshire
Department of
Administrative Services

Civil Engineer / Landscape Architect / Surveyor



SAMYN - D'ELIA
ARCHITECTS, P.A.


20 Main Street, Ashland, NH 03217
(603) 968-7133 / fax: (603) 968-3057
sdarchitects.com

Structural Engineer



T 603-622-4578 500 Commercial Street F 603-622-4593 www.fbra.com Manchester NH 03101

F 603-622-4593 www.fbta.com Malicilestei Nint

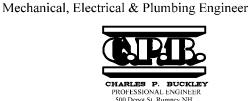

No.	Revision	Date App
	114 (181011	
Designed by	Drawn by MR	Checked by WD
CAD checked by	Approv	ed by WD

Project Title and Location

Jenness Bathhouse Replacement and Parking Lot Improvements 2280 Ocean Boulevard Rye, New Hampshire 03870

Issued for

Construction Documents

Issued: June 30, 2016

Project Number
NHBPW
- 80877B
VHB 52348.05


7B -.05


SDA -1535


Drawing Title


Interior


Elevations

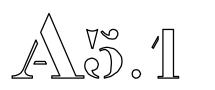

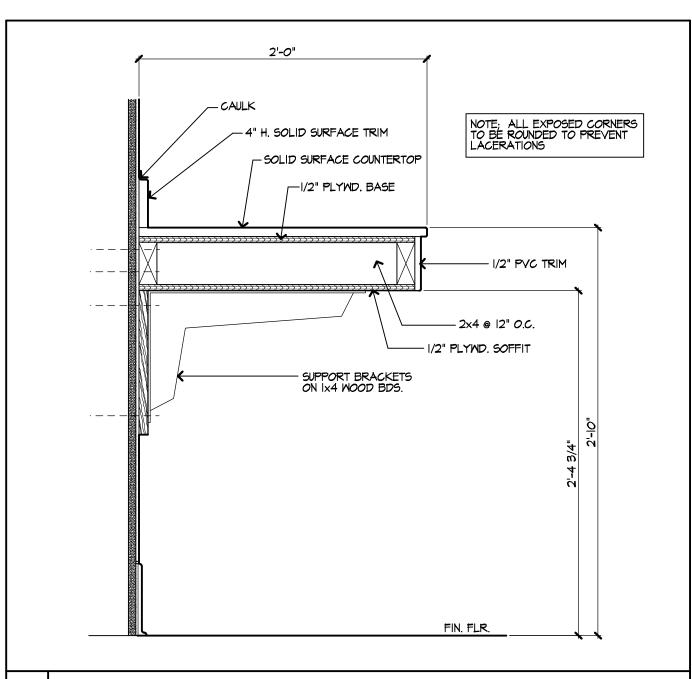

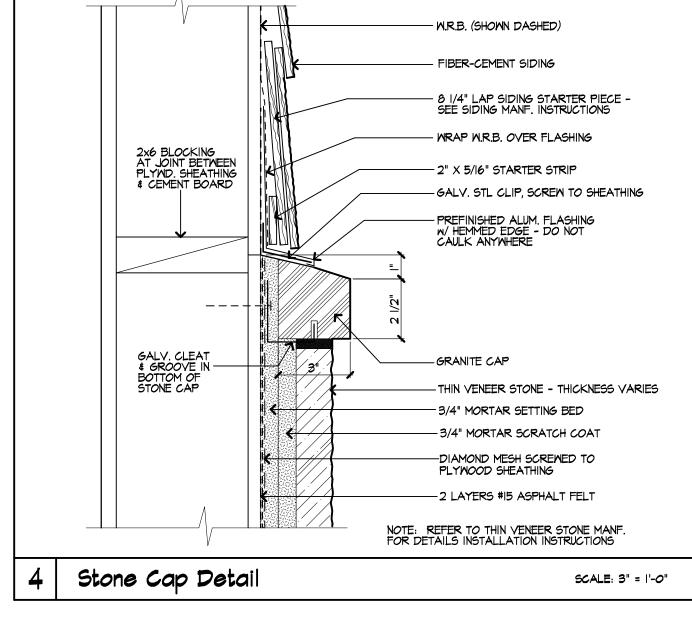

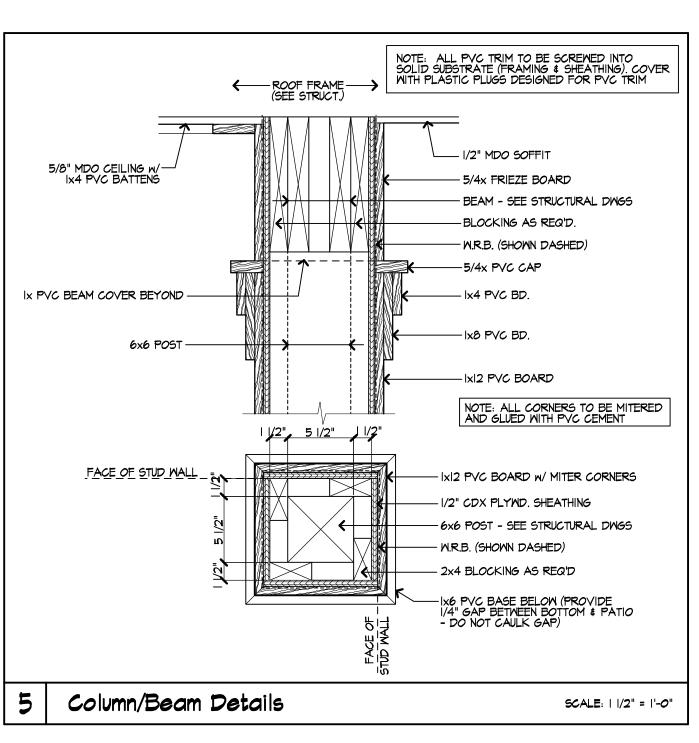

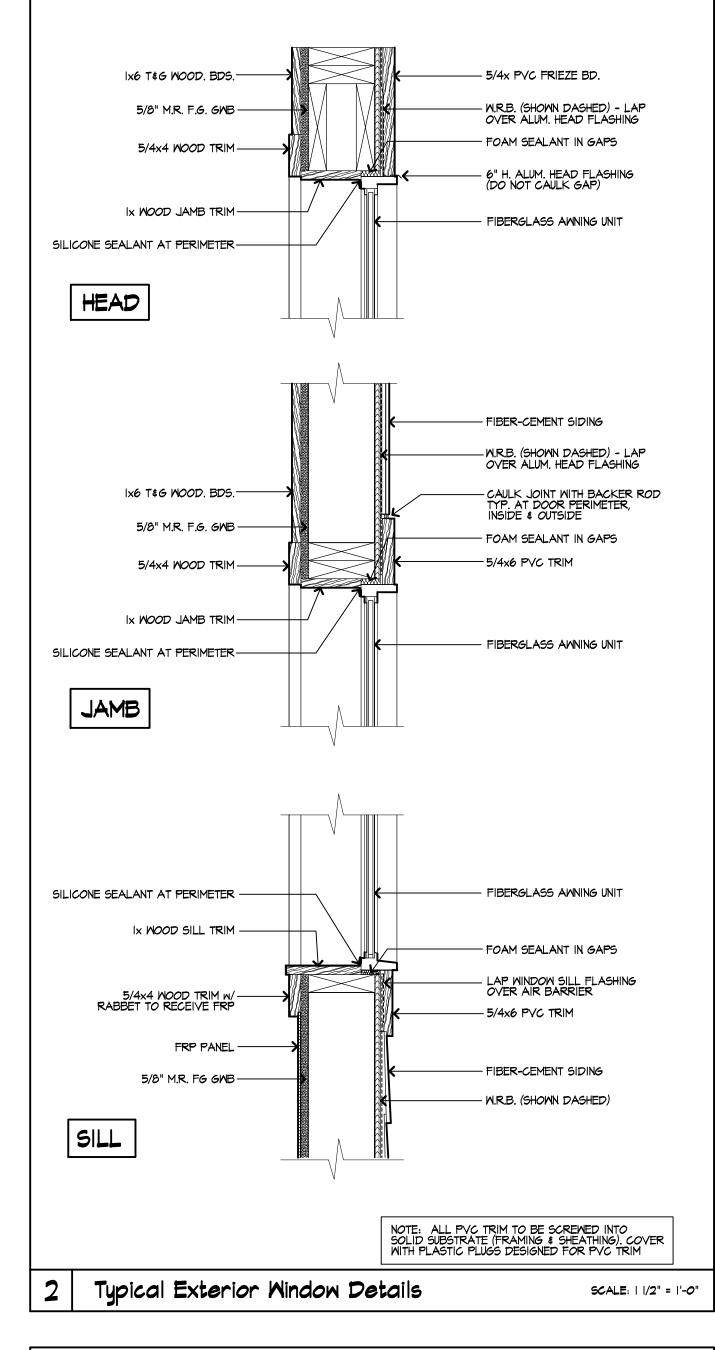

- FIBER-CEMENT SIDING


— W.R.B. (SHOWN DASHED)


— 1/2" PLYMD. SHEATHING


WOOD FRAMING ->


3


Corner PVC Detail

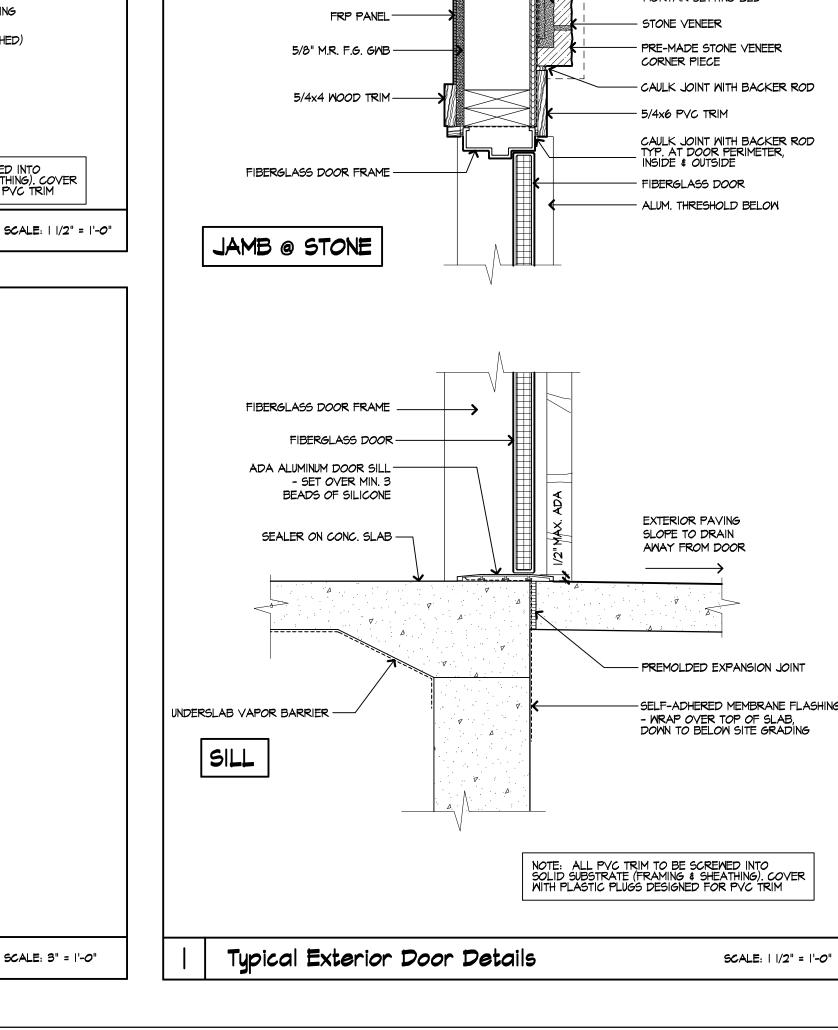


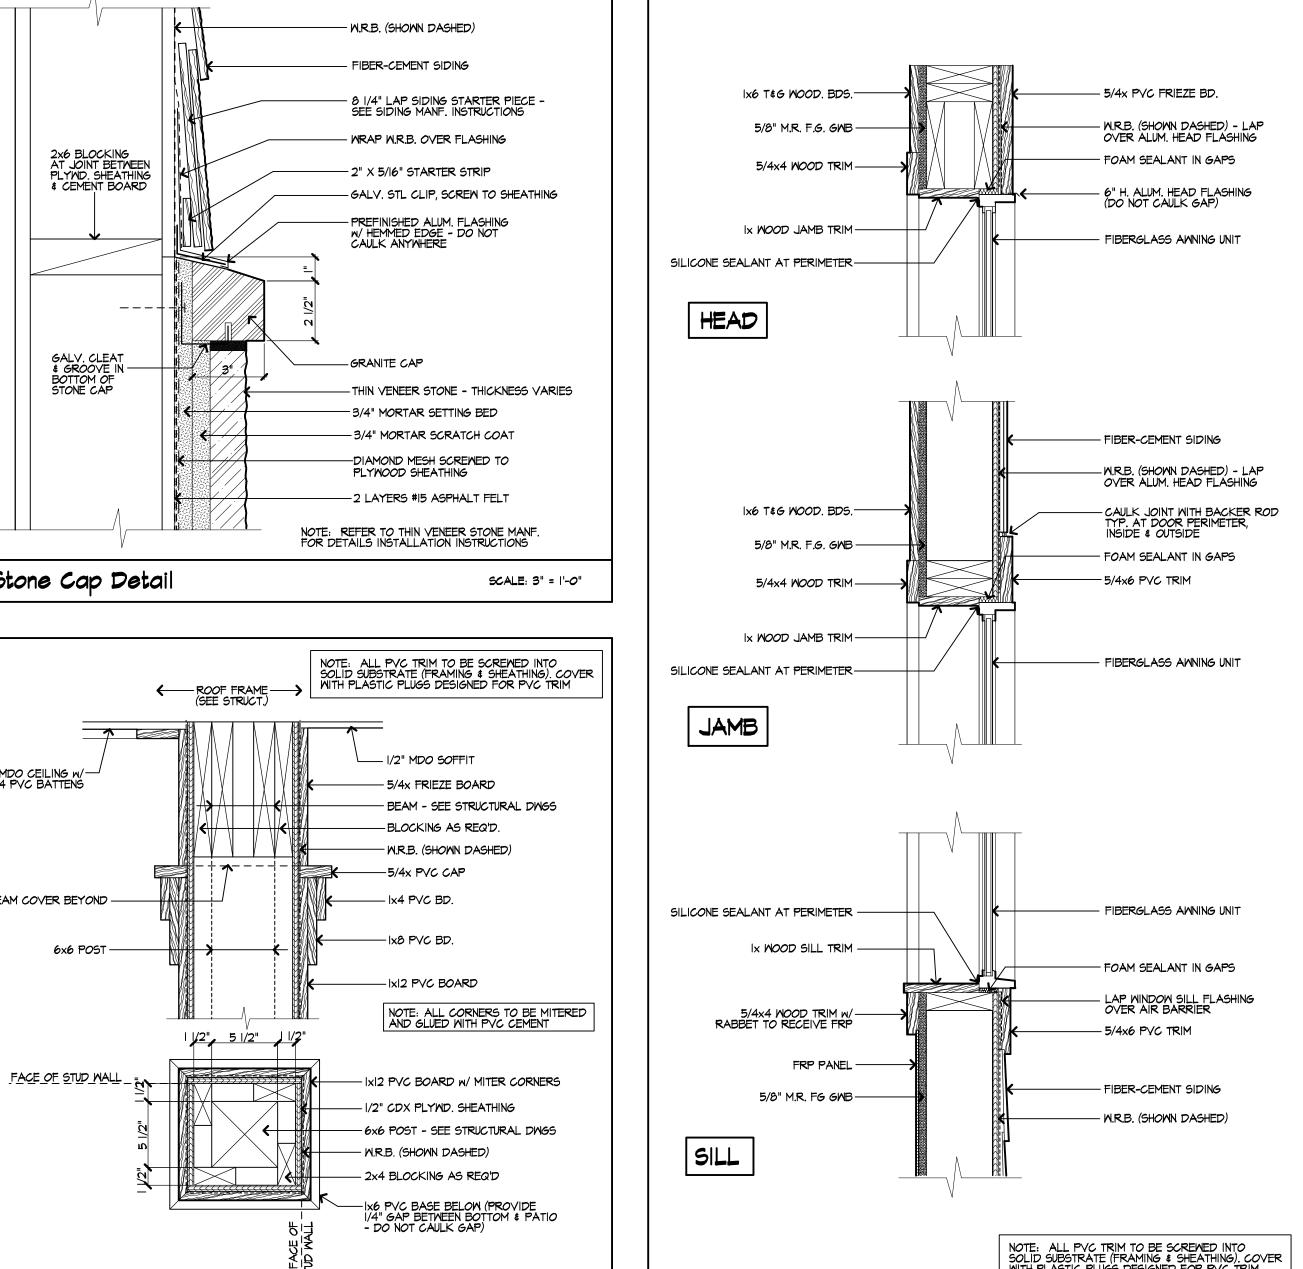

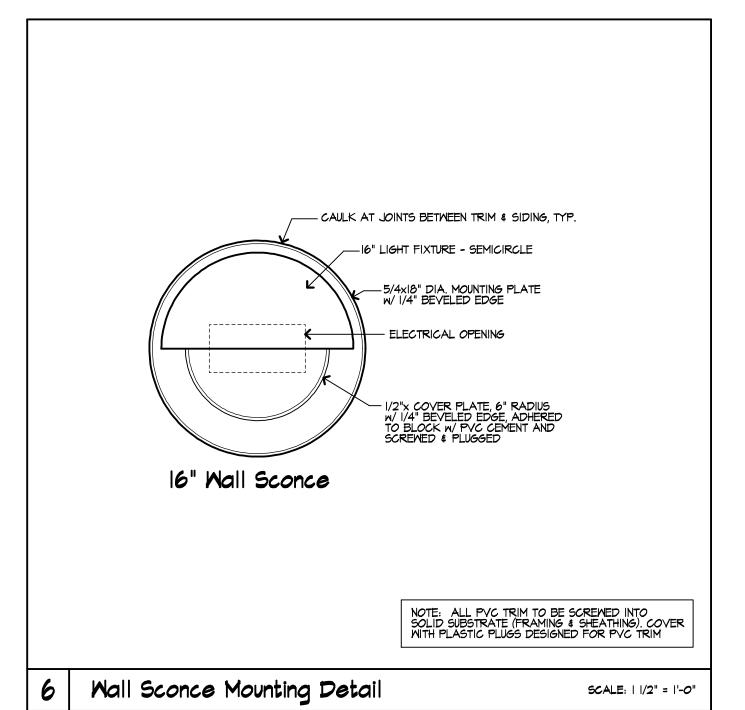

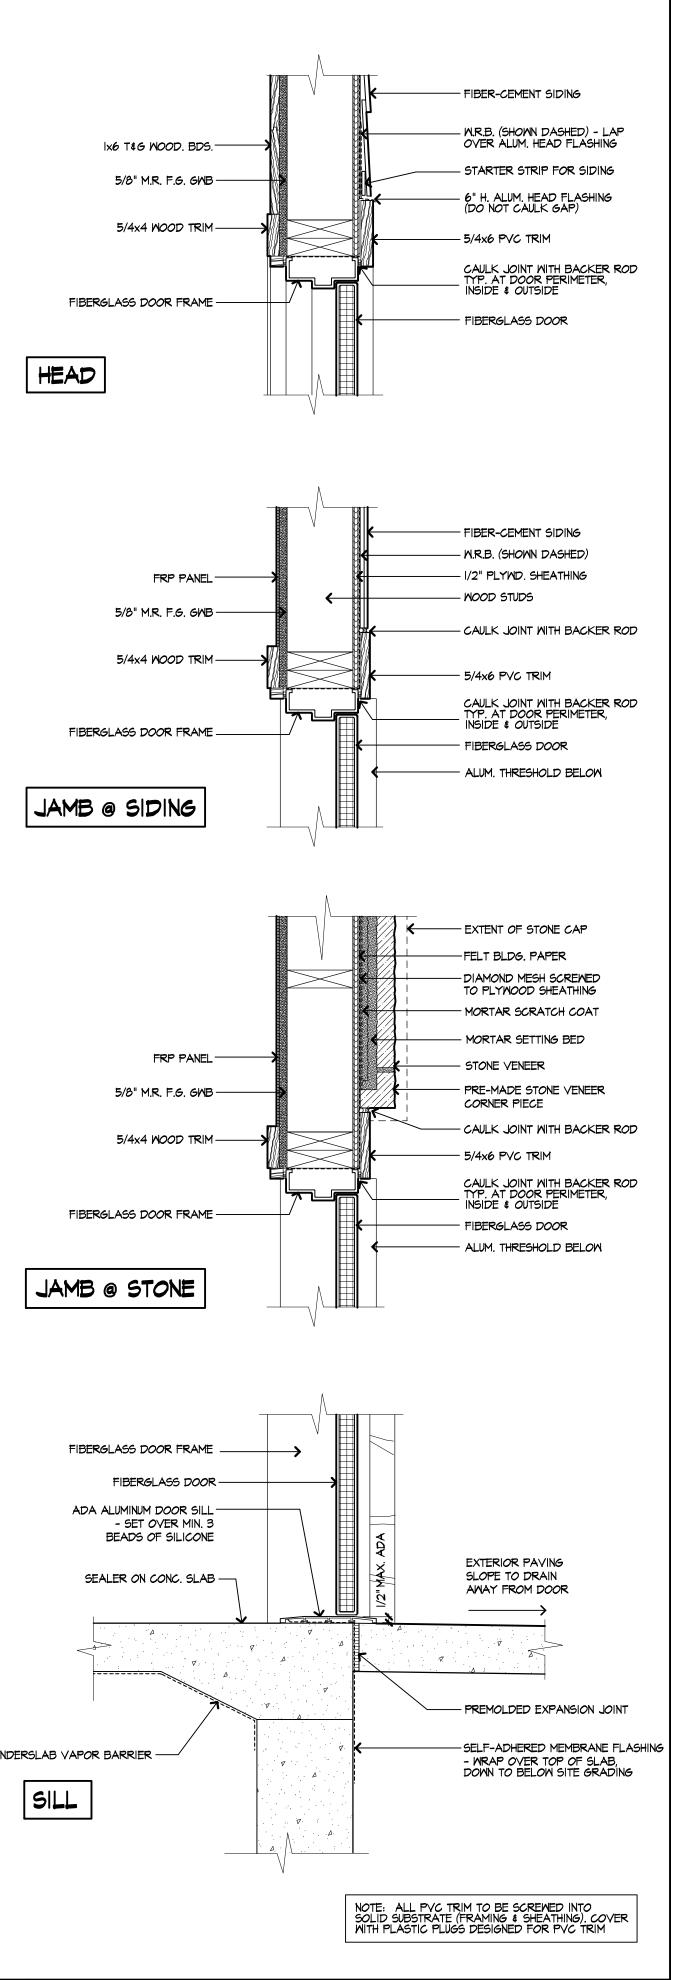

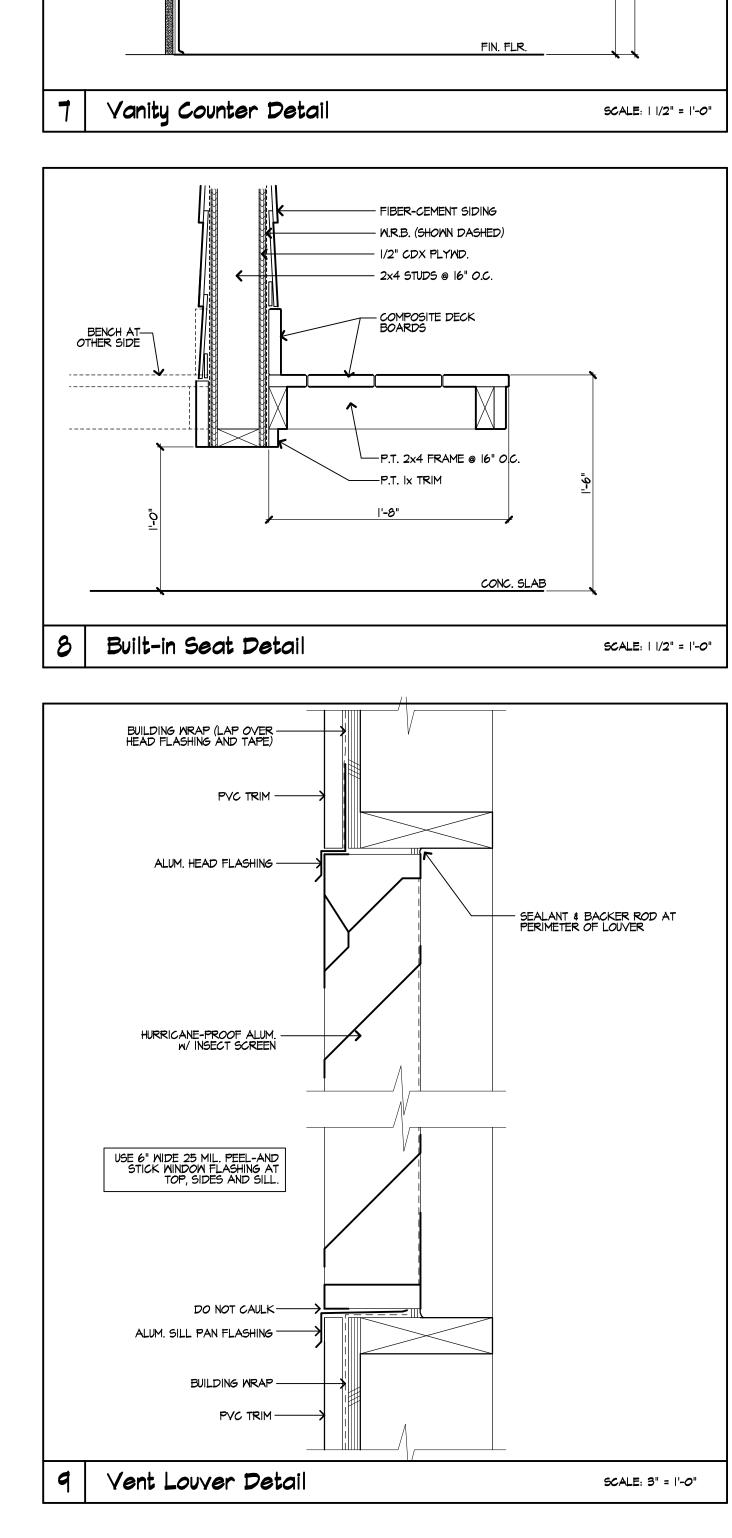

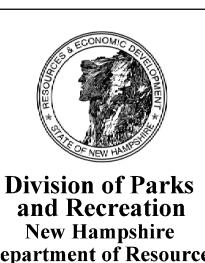

New Hampshire **Department of Resources Economic Development**

Administrator

Division of Public Works, **Design and Construction** New Hampshire Department of Administrative Services

Civil Engineer / Landscape Architect / Surveyor

SAMYN - D'ELIA ARCHITECTS, P.A (603) 968-7133 / fax: (603) 968-3057 sdarchitects.com


Structural Engineer



Bedford, NH 03110

500 Commercial Street T 603-622-4578 F 603-622-4593 www.fbia.com Manchester NH 03101

Mechanical, Electrical & Plumbing Engineer

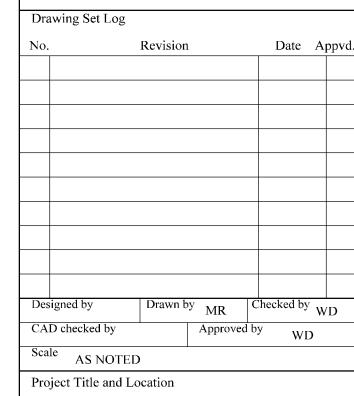

Jenness Bathhouse Replacement and Parking Lot Improvements 2280 Ocean Boulevard Rye, New Hampshire 03870

Issued for

Construction Documents

June 30, 2016 Issued:

Project Number NHBPW - 80877B VHB -52348.05

SDA -


1535


Drawing Title


Details

	WINDOW SCHEDULE							
MARK	ROUGH OPENING	TYPE	MANF.	MODEL NO.	REMARKS			
A	3'- " x '- 5/8"	AMNING	INTEGRITY	IAWN 3723	FIBERGLASS UNIT, IMPACT ZONE 3			
B	3'- " x '- 5/8"	FIXED AWNING	INTEGRITY	IAMN 3723 (FIXED)	FIBERGLASS UNIT, IMPACT ZONE 3			
<u>C</u>	4'- " x '- 5/8"	AMNING	INTEGRITY	IAWN 4923	FIBERGLASS UNIT, IMPACT ZONE 3			

- I. ALL WINDOWS ARE INTEGRITY WOOD-ULTREX BY MARVIN WITH IIO MPH IMPACT SPECIFICATIONS.
- 2. INTERIOR WINDOW FINISH TO BE PRIMED WHITE, PROVIDED BY WINDOW MANUFACTURER.
- 3. ALL WINDOWS TO HAVE OBSCURE GLASS. OPERABLE UNITS TO HAVE SCREENS. (ALTERNATE: CLEAR INSULATING GLASS WITH OBSCURE FILM APPLIED TO INSIDE SURFACE)

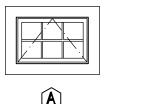


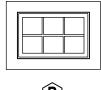

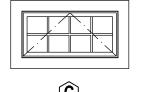


NOTE: SEE TYP. WINDOW DETAILS ON SHT. A6.1 FOR TYP. INSTALLATION DETAILS

WINDOW TYPES

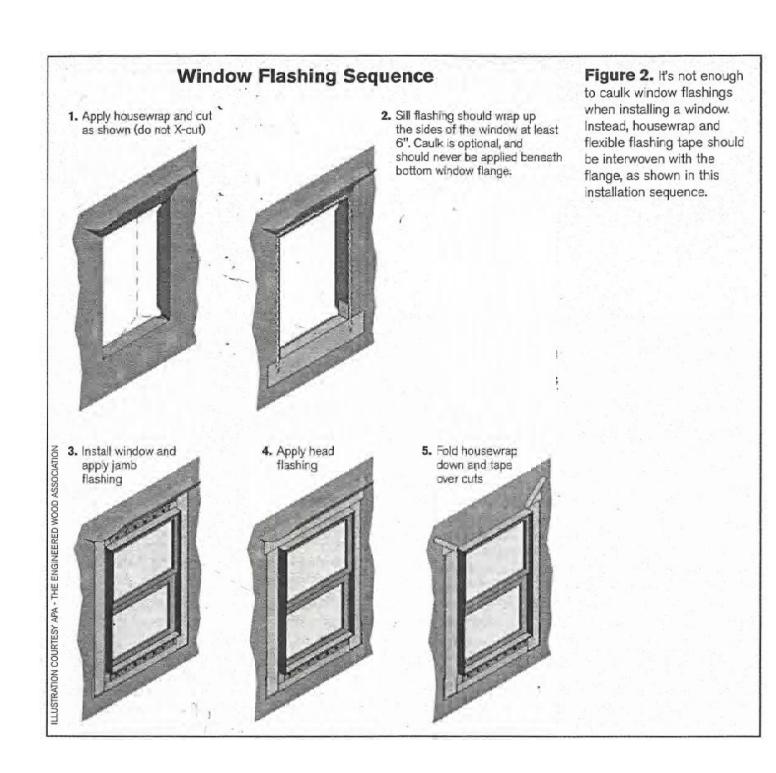

MARK	DOOR SIZE (M x H x T)	TYPE	MATERIAL	HDME	REMARKS
101	3'-0" x 7'-0" x 3/4"	FLUSH	FRP	2, 4, 5, 6, 7	WITH FRP FRAME
102	3'-0" x 7'-0" x 3/4"	FLUSH	FRP	3, 4, 5, 6, 7	WITH FRP FRAME
103	3'-6" × 7'-0" × 3/4"	FLUSH	FRP	1, 4, 5, 6, 7, 8	WITH FRP FRAME
104	3'-6" × 7'-0" × 3/4"	FLUSH	FRP	1, 4, 5, 6, 7, 8	WITH FRP FRAME
105	3'-0" × 7'-0" × 3/4"	FLUSH	FRP	3, 4, 5, 7	WITH FRP FRAME
106	2'-6" × 6'-0" × 3/4"	FLUSH	FRP	2, 4, 5	WITH PVC JAMB TRIM & STOPS - NO FRP FRAM
107	3'-0" × 6'-0" × 3/4"	FLUSH	FRP	2, 4, 5	WITH PVC JAMB TRIM & STOPS - NO FRP FRAM
108	2'-6" × 6'-0" × 3/4"	FLUSH	FRP	2, 4, 5	WITH PVC JAMB TRIM & STOPS - NO FRP FRAM
109	2'-6" × 6'-0" × 3/4"	FLUSH	FRP	2, 4, 5	WITH PVC JAMB TRIM & STOPS - NO FRP FRAM

ALL DOORS AND DOOR FRAMES TO BE COMMERCIAL GRADE FIBERGLASS REINFORCED PLASTIC.

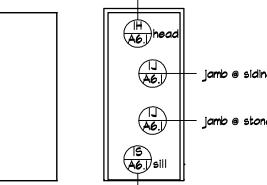

TYPE A TYP. DR. FRAME NOTE: SEE TYP. DOOR DETAILS ON SHEET A6.I FOR TYPICAL INSTALLATION DETAILS (EXCEPT AT CHANGING ROOMS)

HARDWARE SCHEDULE							
REFER TO SPECIFICATIONS FOR ADDITIONAL INFORMATION AND/OR CONSULT HARDWARE VENDOR							
HDME. NO.	HARDWARE TYPE	DESCRIPTION / OPERATION					
I.	PUSH/PULL SET	PUSH PLATE AND PULL BAR					
2.	PRIVACY SET	OUTSIDE LEVER LOCKS WITH PUSH BUTTON INSIDE ONLY					
3.	STORAGE SET	LOCKS/UNLOCKS DOOR FROM OUTSIDE WITH KEY, INSIDE LEVER ALWAYS UNLOCKED					
4.	CLOSER	DOOR OR FRAME MOUNTED					
5.	DEADBOLT	DEADBOLT WITH MIN. I" THROW, KEYED FROM OUTSIDE					
6.	WEATHER STRIPPING	DOOR BOTTOM SMEEP, RUBBER GASKETS IN JAMBS AND HEADS OF DOOR FRAMES					
٦.	KICKPLATE	6" HIGH X WIDTH OF DOOR MINUS 2 INCHES, BOTH SIDES					
	DOOR KEEPER	HOLDS DOOR OPEN DURING OPERATING HOURS, WALL MOUNTED					

HARDWARE NOTES

- I. ALL LATCH SETS SHALL BE EQUIPPED WITH LEVERS.
- 2. THUMB ACTUATED LATCHES ARE NOT PERMITTED. 3. ROUND KNOBS ARE NOT PERMITTED.

stone
RDWARE SCHEDULE
ONS FOR ADDITIONAL INFORMATION AND/OR CONSULT HARDWARE VENDOR
DESCRIPTION / OPERATION

	FINISH NOTES
NO.	NOTES
ı.	ALL DIMENSIONS SHALL BE FIELD VERIFIED.
2.	ALL FINISHES ARE TO BE INSTALLED IN ACCORDANCE WITH ALL MANUFACTURER'S SPECIFICATIONS AND DIRECTIONS.
3.	ALL CONTRACTORS/VENDORS ARE RESPONSIBLE FOR OBTAINING AND FOLLOWING ALL MANUFACTURER'S SPECIFICATIONS AND DIRECTIONS.
4.	ALL FLOOR PREP WORK IS TO MEET FLOORING MANUFACTURER'S SPEC. FOR THEIR PRODUCT. ALL FLOOR PREP WORK BY G.C.
5.	FLOOR FINISH INSTALLER SHALL VERIFY FLOOR STRUCTURE FOR ABILITY TO ACCEPT FLOOR FINISH. INSTALLER SHALL BE RESPONSIBLE TO NOTIFY THE C.M. OF APPROVAL OR REJECTION OF THE FLOOR'S ABILITY TO RECEIVE TILE, PRIOR TO ANY FLOORING INSTALLATION.
6.	ALL FLOOR AND WALL FINISHES ARE TO BE PROVIDED AS SPECIFIED. NO SUBSTITUTIONS. IF PRODUCT IS UNAVAILABLE C.M. SHALL INFORM ARCHITECT.

PROVIDE MFR'S. PROTECTIVE VINYL EDGE FOR BOTTOM EDGE OF ALL FRP WAINSCOT.

	FINISH SCHEDULE									
žM.					MAL	LS				
0 .	ROOM NAME	FLOOR	BASE	NORTH	EAST	SOUTH	WEST	TRIM	CEILING	REMARKS
<u>ار</u>	FAMILY TOILET ROOM	F-I	B-I	W-I, W-2	W-1, W-2	W-3, W-5	W-1, W-2	-	C-I	ALTERNATE: F-3 \$ B-3
22	MECHANICAL/STORAGE	F -I	B-2	W-5	W-1, W-5	W-5	M-I	-	C-2	
23	ENTRY	F-I	B-I	M-1, M-3, M-4	W-2, W-4	W-2, W-4	W-3, W-4	-	C-I	ALTERNATE: F-3 & B-3
24	MENS RESTROOM	F-I	B-I	W-3, W-4	W-2, W-4	W-2, W-4	M-3, M-4	-	C-I	ALTERNATE: F-3 \$ B-3
<i>0</i> 5	Plumbing access room	F-2	-	-	-	-	•	-	-	UNFINISHED SPACE
26	ENTRY	F -I	B-I	W-2, W-4	W-2, W-4	W-2	W-2, W-4	-	C-I	ALTERNATE: F-3 \$ B-3
77	WOMENS RESTROOM	F- I	B-I	W-2	W-2, W-4	W-2, W-4	W-2, W-4	-	C-I	ALTERNATE: F-3 ¢ B-3

	r finishes: 	<u></u>	
CODE	TYPE	DESCRIPTION	REMARKS
F- I	SEALER	CONCRETE FLOOR SEALER WITH STAIN	
F-2	GRAVEL	GRAVEL FLOOR, NO VAPOR BARRIER	
F-3	QUARRY TILE	6" x 6" QUARRY TILE	ALTERNATE TO F-I IN ROOMS IOI, IO3, IO4, IO6 \$ IO7 ONLY.
MALL	BASES:		-
CODE	TYPE	DESCRIPTION	
B-I	CERAMIC TILE	6" HIGH CERAMIC TILE COVE BASE WITH SANDED EPOXY GROUT	
B-2	RUBBER BASE	4" HIGH RUBBER BASE	
		6" HIGH QUARRY TILE COVE BASE W/ BULLNOSE EDGE	ALTERNATE TO B-I IN ROOMS IOI, IO3, IO4,
B-3	QUARRY TILE	P HIGH GUARRY TILL COVE BASE W BULLNOSE EDGE	106 \$ 107 ONLY.
MALL	FINISHES:	DESCRIPTION	REMARKS
MALL	FINISHES:	DESCRIPTION	
MALL code w-i	FINISHES:		
MALL CODE W-I W-2	FINISHES:	DESCRIPTION 5/8" M.R. FIBERGLASS REINFORCED DRYWALL, PAINTED	
MALL CODE M-1 M-2 M-3	TYPE GWB GWB/FRP WAINSCOT	DESCRIPTION 5/8" M.R. FIBERGLASS REINFORCED DRYWALL, PAINTED 5/8" M.R. FIBERGLASS REINFORCED DRYWALL WITH FRP WAINSCOT & VINYL EDGE	
MALL CODE M-1 M-2 M-3 M-4	FINISHES: TYPE GWB GWB/FRP WAINSCOT GWB/FRP WAINSCOT	DESCRIPTION 5/8" M.R. FIBERGLASS REINFORCED DRYWALL, PAINTED 5/8" M.R. FIBERGLASS REINFORCED DRYWALL WITH FRP WAINSCOT & VINYL EDGE 5/8" TYPE 'X' M.R. FIBERGLASS REINFORCED DRYWALL WITH FRP WAINSCOT & VINYL EDGE	
MALL CODE M-1 M-2 M-3 M-4	TYPE GWB GWB/FRP WAINSCOT GWB/FRP WAINSCOT T#G WOOD PANELING	DESCRIPTION 5/8" M.R. FIBERGLASS REINFORCED DRYWALL, PAINTED 5/8" M.R. FIBERGLASS REINFORCED DRYWALL WITH FRP WAINSCOT & VINYL EDGE 5/8" TYPE 'X' M.R. FIBERGLASS REINFORCED DRYWALL WITH FRP WAINSCOT & VINYL EDGE HORIZONTAL IX6 T&G WOOD PANELING ABOVE 5/4x4 WOOD BAND	
MALL CODE W-1 W-2 W-3 W-4 W-5	TYPE GWB GWB/FRP WAINSCOT GWB/FRP WAINSCOT T&G WOOD PANELING TYPE 'X' GWB	DESCRIPTION 5/8" M.R. FIBERGLASS REINFORCED DRYWALL, PAINTED 5/8" M.R. FIBERGLASS REINFORCED DRYWALL WITH FRP WAINSCOT & VINYL EDGE 5/8" TYPE 'X' M.R. FIBERGLASS REINFORCED DRYWALL WITH FRP WAINSCOT & VINYL EDGE HORIZONTAL IX6 T&G WOOD PANELING ABOVE 5/4x4 WOOD BAND	
MALL CODE M-1 M-2 M-3 M-4 M-5	FINISHES: TYPE GWB GWB/FRP WAINSCOT T&G WOOD PANELING TYPE 'X' GWB G FINISHES:	DESCRIPTION 5/8" M.R. FIBERGLASS REINFORCED DRYWALL, PAINTED 5/8" M.R. FIBERGLASS REINFORCED DRYWALL WITH FRP WAINSCOT & VINYL EDGE 5/8" TYPE 'X' M.R. FIBERGLASS REINFORCED DRYWALL WITH FRP WAINSCOT & VINYL EDGE HORIZONTAL IX6 T&G WOOD PANELING ABOVE 5/4x4 WOOD BAND 5/8" TYPE 'X' M.R. FIBERGLASS REINFORCED DRYWALL, PAINTED	
WALL CODE N-1 N-2 N-3 N-4 N-5	TYPE GWB GWB/FRP WAINSCOT GWB/FRP WAINSCOT T&G WOOD PANELING TYPE 'X' GWB	DESCRIPTION 5/8" M.R. FIBERGLASS REINFORCED DRYWALL, PAINTED 5/8" M.R. FIBERGLASS REINFORCED DRYWALL WITH FRP WAINSCOT & VINYL EDGE 5/8" TYPE 'X' M.R. FIBERGLASS REINFORCED DRYWALL WITH FRP WAINSCOT & VINYL EDGE HORIZONTAL IX6 T&G WOOD PANELING ABOVE 5/4x4 WOOD BAND	
MALL CODE M-1 M-2 M-3 M-4 M-5	FINISHES: TYPE GWB GWB/FRP WAINSCOT T&G WOOD PANELING TYPE 'X' GWB G FINISHES:	DESCRIPTION 5/8" M.R. FIBERGLASS REINFORCED DRYWALL, PAINTED 5/8" M.R. FIBERGLASS REINFORCED DRYWALL WITH FRP WAINSCOT & VINYL EDGE 5/8" TYPE 'X' M.R. FIBERGLASS REINFORCED DRYWALL WITH FRP WAINSCOT & VINYL EDGE HORIZONTAL IX6 T&G WOOD PANELING ABOVE 5/4x4 WOOD BAND 5/8" TYPE 'X' M.R. FIBERGLASS REINFORCED DRYWALL, PAINTED	REMARKS



Division of Parks and Recreation

New Hampshire Department of Resources

Economic Development

Administrator

Division of Public Works, **Design and Construction**

New Hampshire Department of Administrative Services

Civil Engineer / Landscape Architect / Surveyor

SAMYN - D'ELIA ARCHITECTS, P.A. 20 Main Street, Ashland, NH 03217 (603) 968-7133 / fax: (603) 968-3057 sdarchitects.com

Structural Engineer

Foley Buhl Roberts

ASSOCIATES INC. structural engineers

500 Commercial Street T 603-622-4578 F 603-622-4593 www.fbra.com Manchester NH 03101

Mechanical, Electrical & Plumbing Engineer

Drawing Set Log Date Appvd. Revision CAD checked by Scale AS NOTED

Project Title and Location


Jenness Bathhouse Replacement and Parking Lot Improvements 2280 Ocean Boulevard Rye, New Hampshire 03870

Issued for

Construction Documents

Issued: June 30, 2016


Project Number NHBPW **-** 80877B VHB -52348.05 SDA -1535

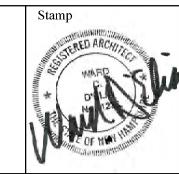

Drawing Title

Schedules



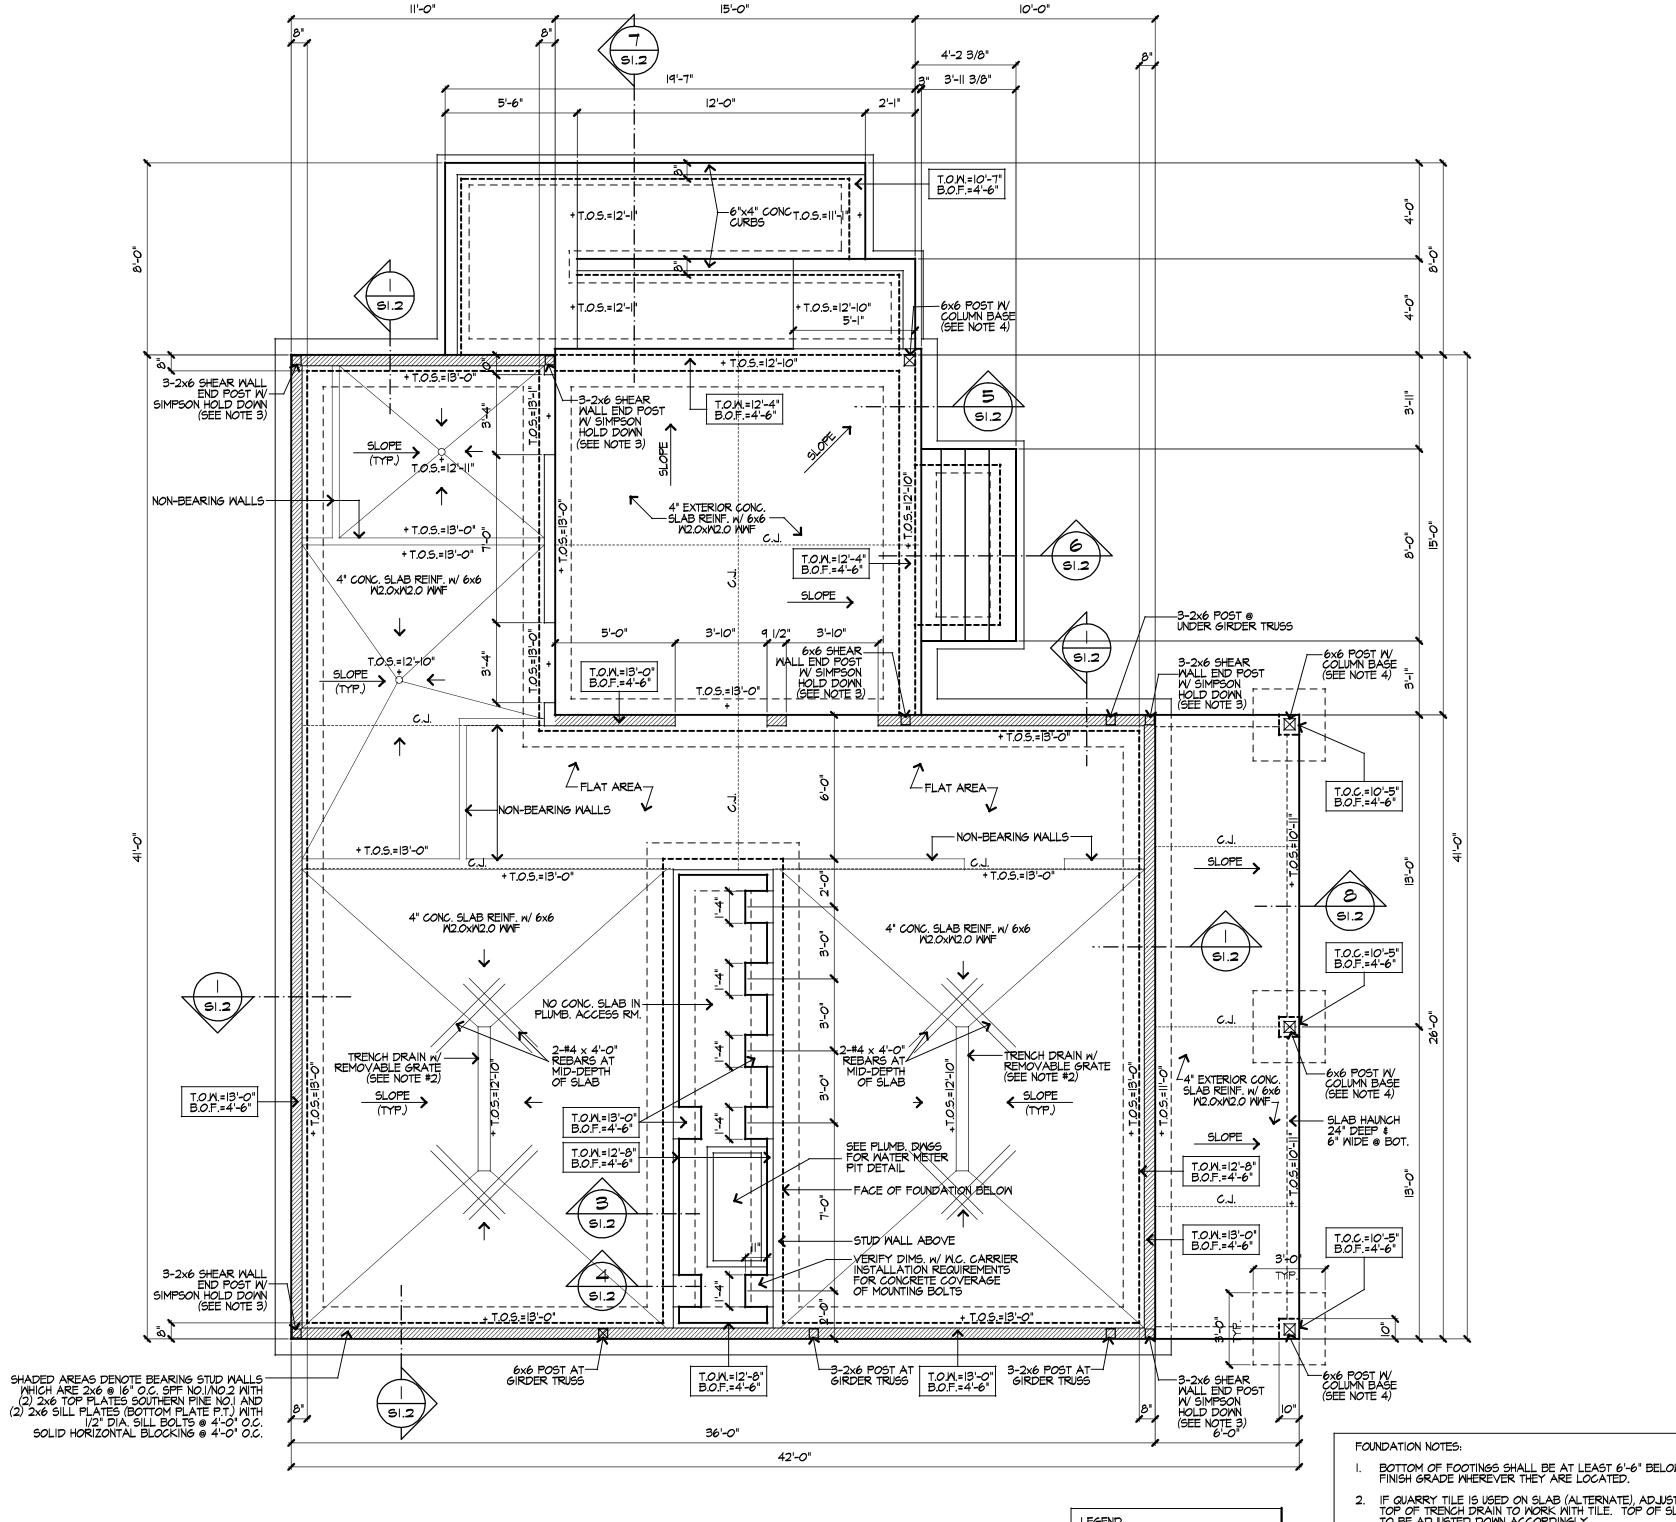

Foundation Plan

SCALE: 1/4"=1'-0"

LEGEND T.O.W. = TOP OF CONC. WALL T.O.C. = TOP OF CONCRETE (PIER) T.O.S. - TOP OF SLAB B.O.F. = BOTTOM OF FOOTING C.J. = CONTROL JOINT BOTTOM OF FOOTINGS SHALL BE AT LEAST 6'-6" BELOW FINISH GRADE WHEREVER THEY ARE LOCATED.

IF QUARRY TILE IS USED ON SLAB (ALTERNATE), ADJUST TOP OF TRENCH DRAIN TO WORK WITH TILE. TOP OF SLAB TO BE ADJUSTED DOWN ACCORDINGLY.

ALL SHEAR WALL END POSTS (6 TOTAL) TO RECEIVE SIMPSON HDU-SDS2.5 HOLD DOWN WITH A SIMPSON SSTB2OL ANCHOR BOLT

. INDIVIDUAL 6x6 POSTS (4 TOTAL) TO RECEIVE SIMPSON CBSQ COLUMN BASE.



Division of Parks and Recreation New Hampshire Department of Resources **Economic Development**

Division of Public Works, **Design and Construction** New Hampshire

Department of Administrative Services

Civil Engineer / Landscape Architect / Surveyor



SAMYN - D'ELIA ARCHITECTS, P.A. (603) 968-7133 / fax: (603) 968-3057 sdarchitects.com

Structural Engineer

structural engineers

Foley Buhl Roberts

& ASSOCIATES INC

T 603-622-4578 500 Commercial Street F 603-622-4593 www.fbra.com Manchester NH 03101

Mechanical, Electrical & Plumbing Engineer



Drawing Set Log

No.	Revision	Date Appv
Designed by	Drawn by MR	Checked by WD
CAD checked	by Appro	ved by WD

Jenness Bathhouse Replacement and Parking Lot Improvements 2280 Ocean Boulevard Rye, New Hampshire 03870

Issued for

Project Title and Location


Construction Documents Issued: June 30, 2016


Project Number NHBPW - 80877B VHB -52348.05 SDA -


1535

Drawing Title

Foundation Plan

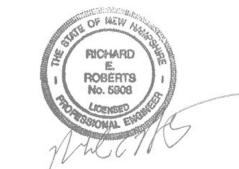

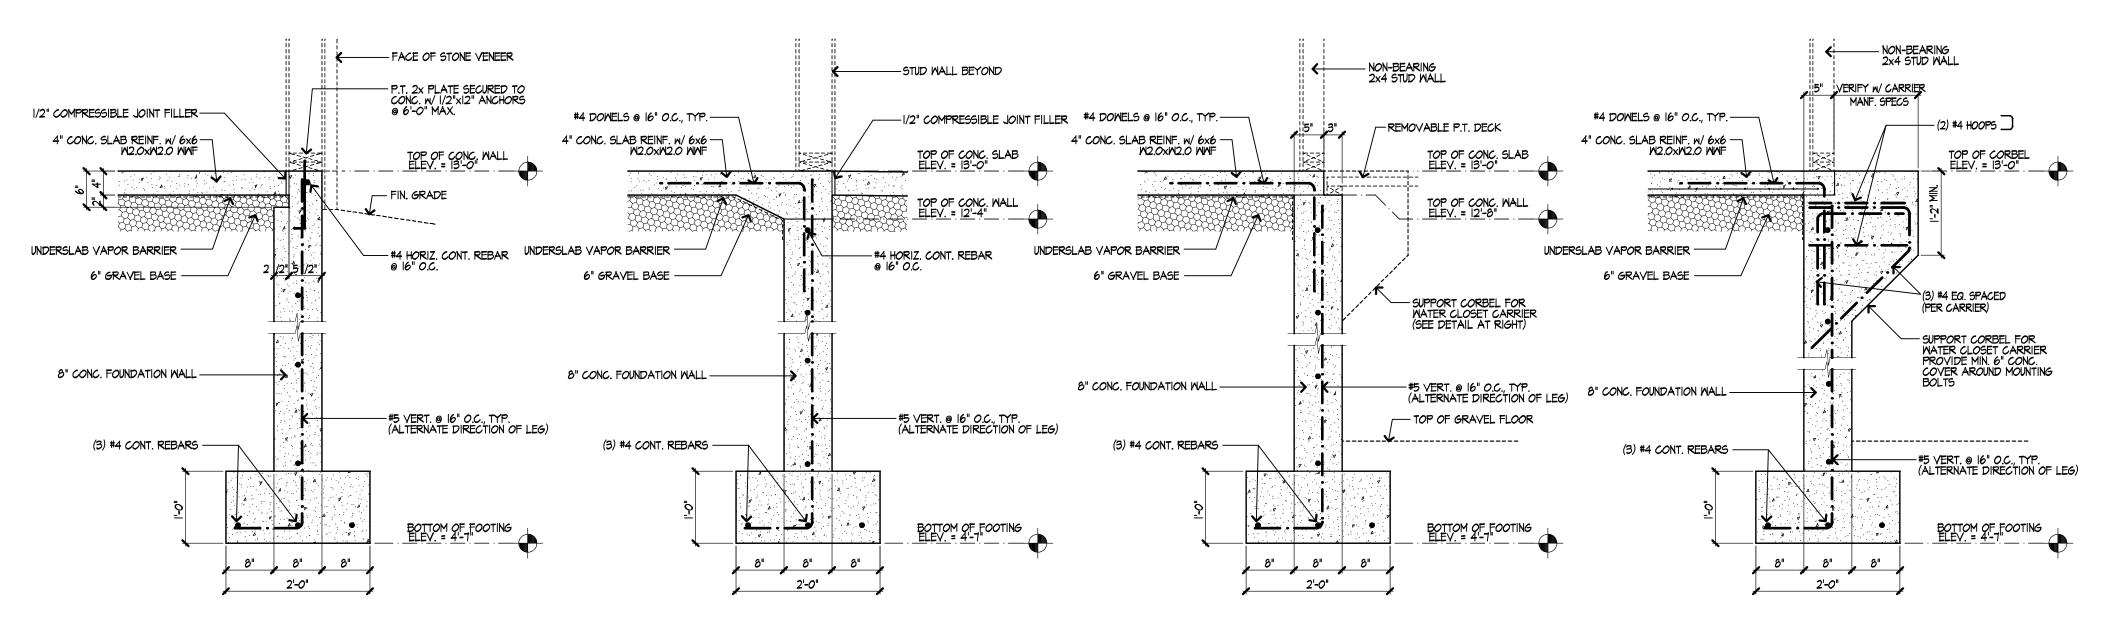

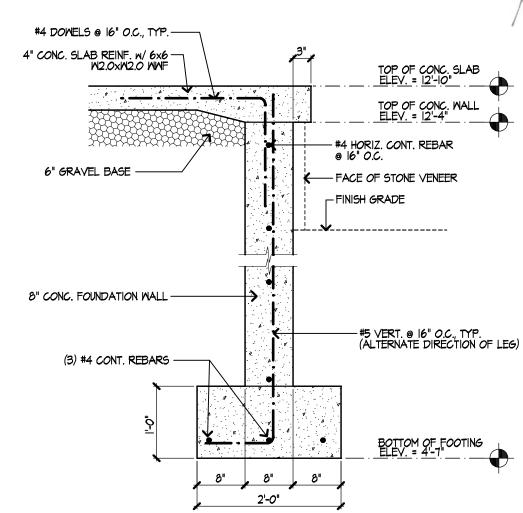

Typical Foundation Wall Detail

SCALE: 3/4" = 1'-0"

Foundation Wall Detail at Door

SCALE: 3/4" = 1'-0"

Foundation Wall Detail at Plumbing


SCALE: 3/4" = 1'-0"


Foundation Wall Detail at Plumbing

SCALE: 3/4" = 1'-0"

Foundation Wall Detail at Patio Edge

SCALE: 3/4" = 1'-0"

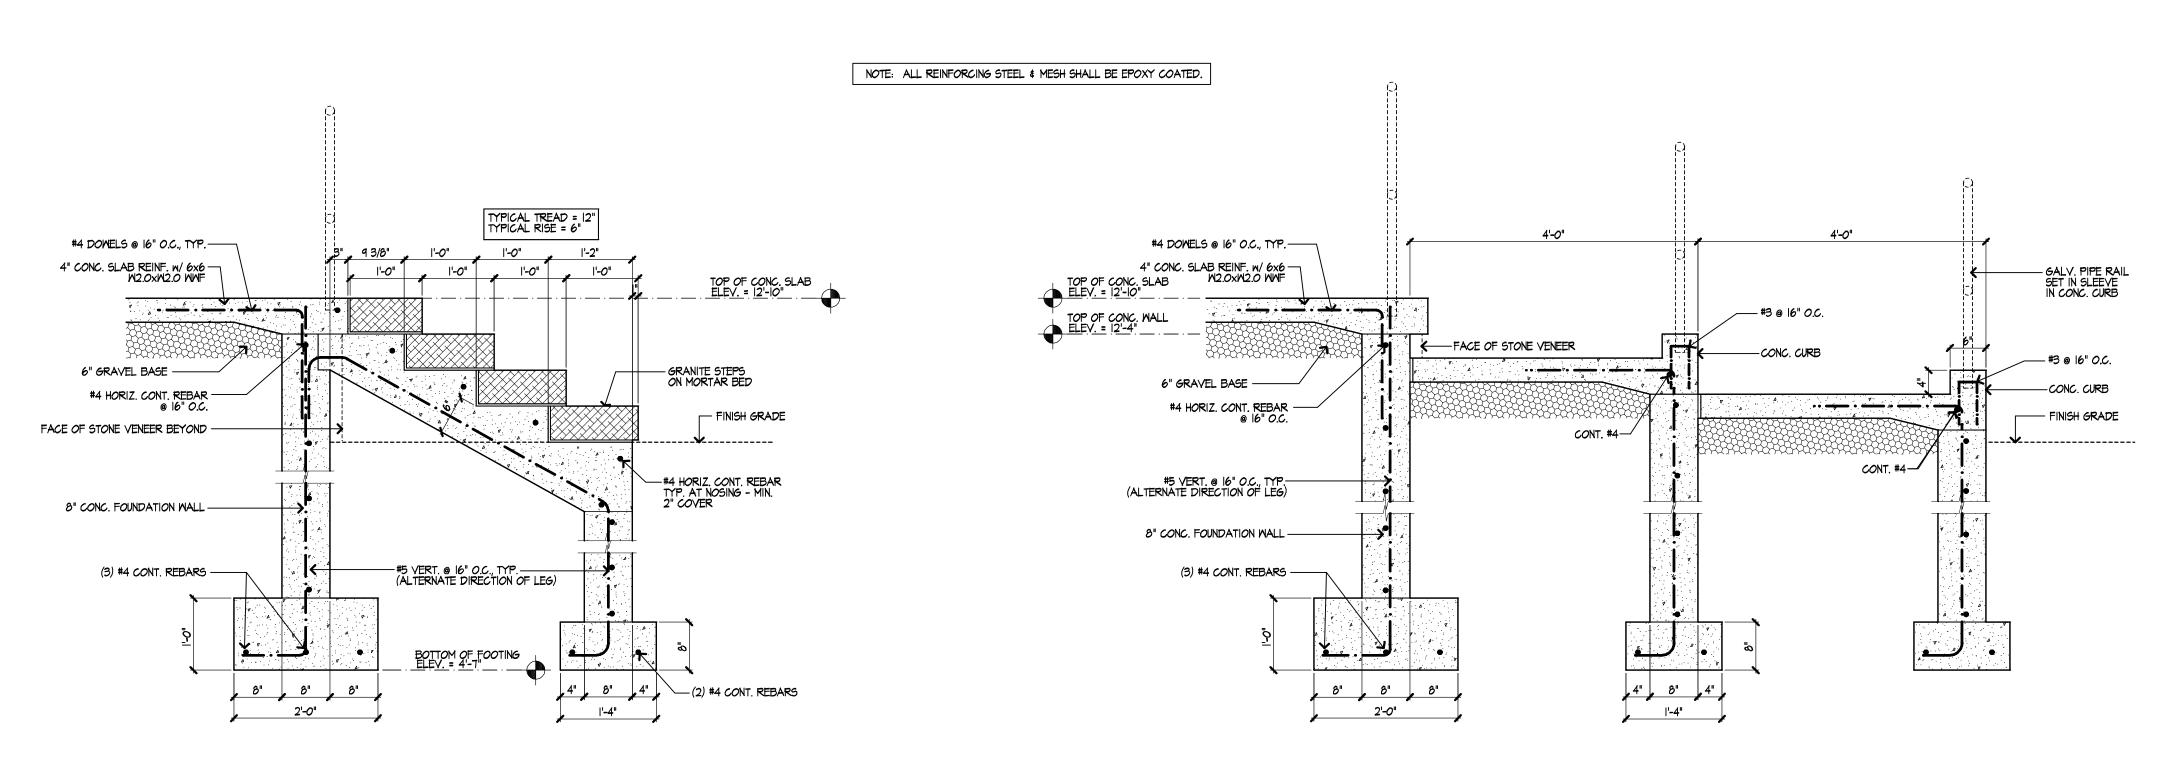

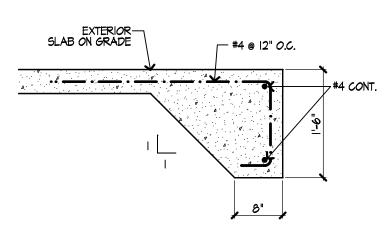

Foundation Wall Detail at Steps

SCALE: 3/4" = 1'-0"

Foundation Wall Detail at Ramp

SCALE: 3/4" = 1'-0"

Slab Edge Detail

5cale: 3/4" = 1'-0"



Division of Parks and Recreation New Hampshire Department of Resources and

Administrator

Division of Public Works, Design and Construction

Economic Development

New Hampshire
Department of
Administrative Services

Civil Engineer / Landscape Architect / Surveyor

2 Bedford Farms
Drive
Suite 200
Bedford, NH 03110

SAMYN - D'ELIA ARCHITECTS, P.A. 20 Main Street, Ashland, NH 03217 (603) 968-7133 / fax: (603) 968-3057 sdarchitects.com

Structural Engineer

structural engineers

Foley Buhl Roberts
& ASSOCIATES INC

T 603-622-4578 500 Commercial Street F 603-622-4593 www.fbra.com Manchester NH 03101

Mechanical, Electrical & Plumbing Engineer



Drawing Set Log	•		
No.	Revision	Γ	Date App
Designed by	Drawn by M	R Check	red by WD
CAD checked by	App	proved by	WD
Scale AS NOT	ED		
Project Title and	Location		

Jenness Bathhouse Replacement and Parking Lot Improvements 2280 Ocean Boulevard Rye, New Hampshire 03870

Issued for

Construction Documents
Issued: June 30, 2016

Project Number Stamp


NHBPW
- 80877B


VHB - 52348.05

SDA - 1535

Drawing Title

Foundation Details & Notes

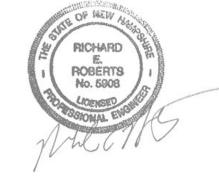

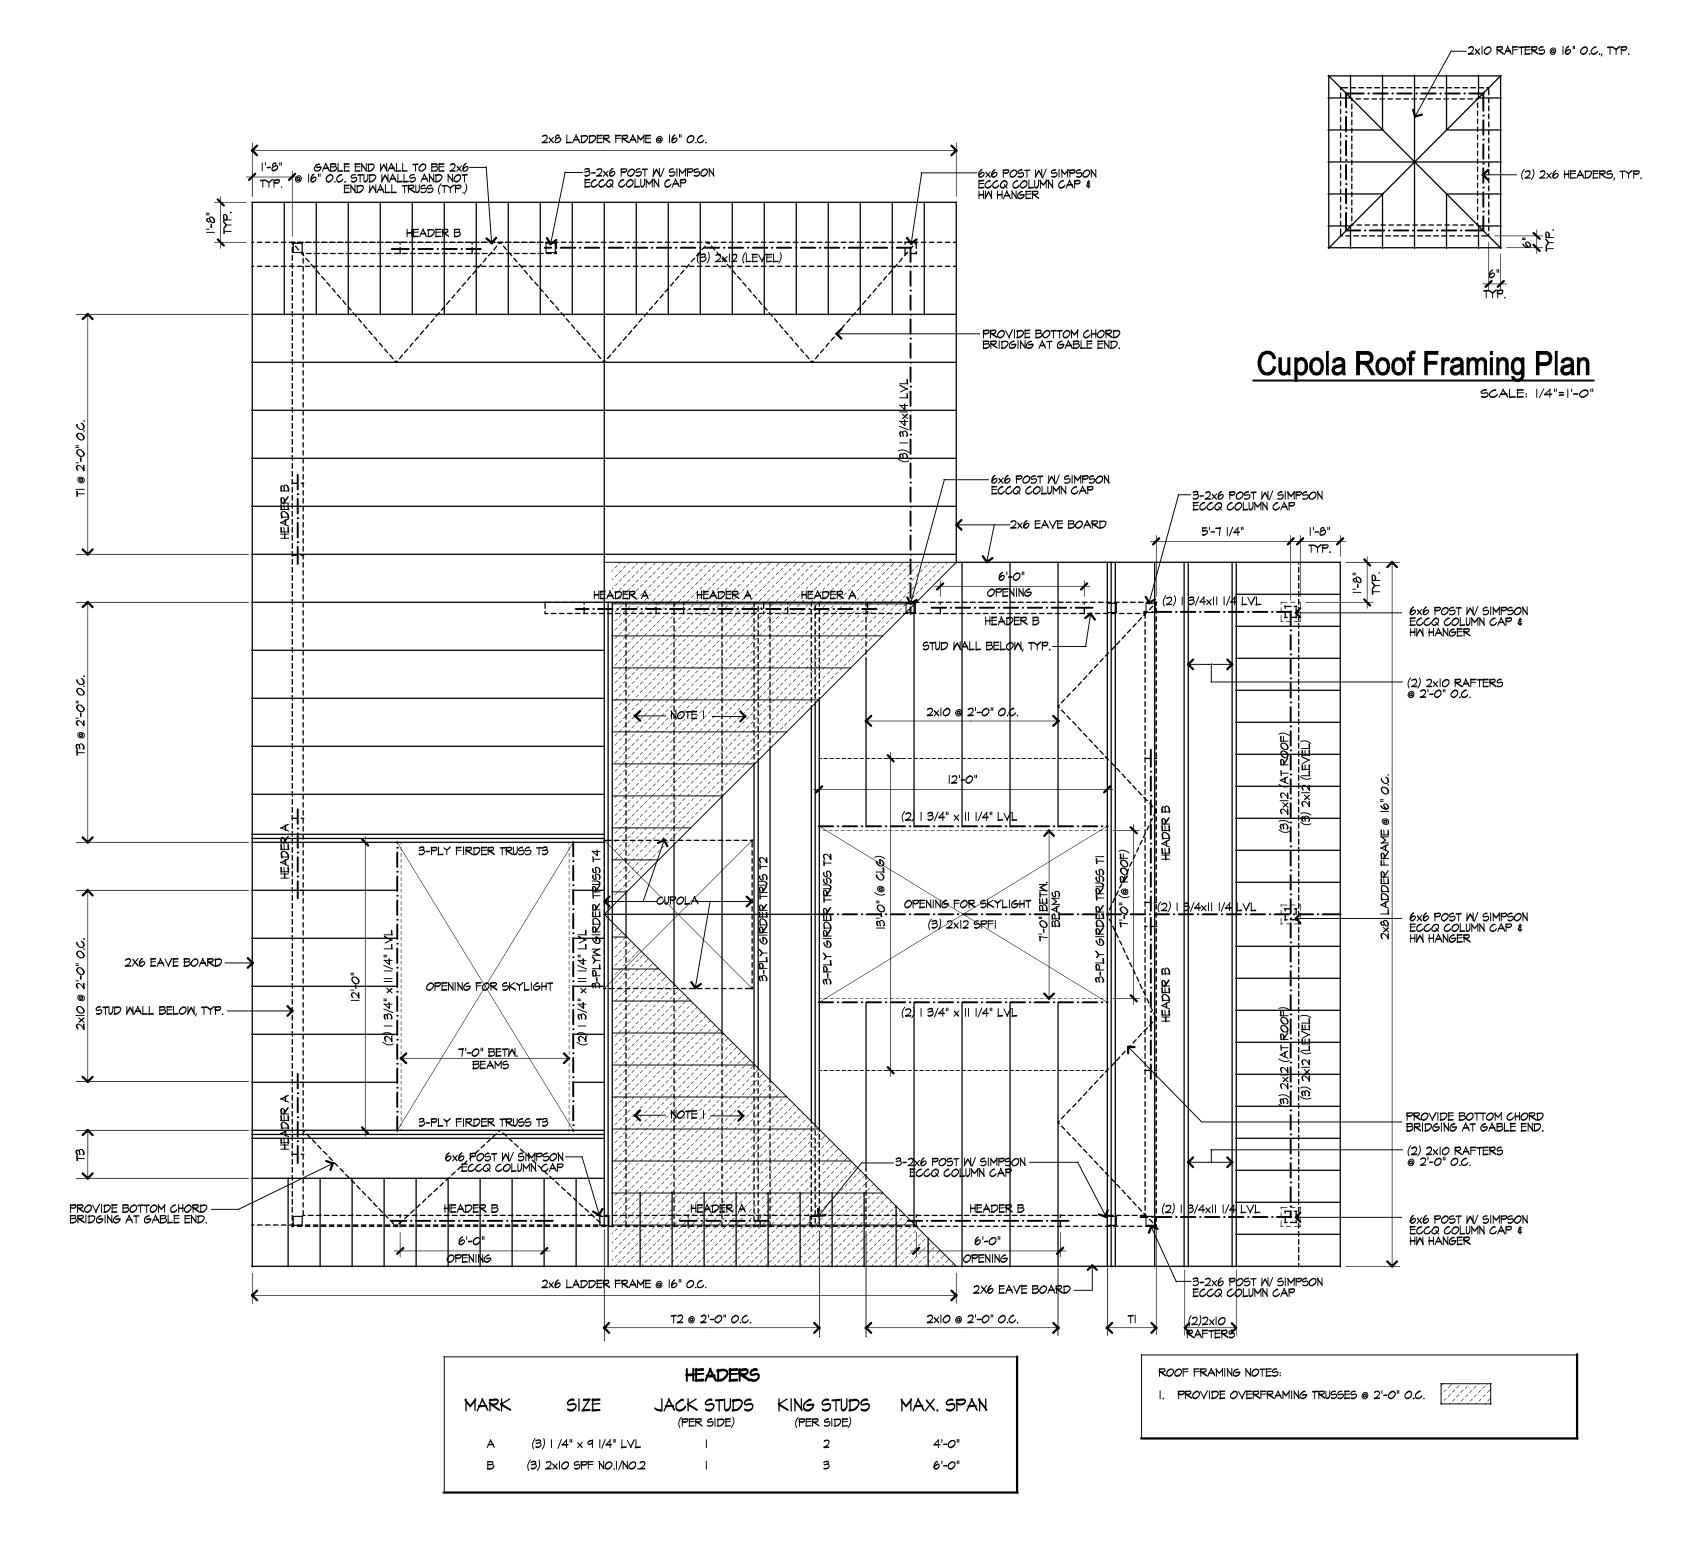





Division of Parks and Recreation New Hampshire Department of Resources and

Economic Development

Administrator

_ . . .

Division of Public Works, Design and Construction

New Hampshire
Department of
Administrative Services

Civil Engineer / Landscape Architect / Surveyor



SAMYN - D'ELIA
ARCHITECTS, P.A.

20 Main Street, Ashland, NH 03217
(603) 968-7133 / fax: (603) 968-3057
sdarchitects.com

Structural Engineer



T 603-622-4578 500 Commercial Street
F 603-622-4593 www.fbia.com Manchester NH 03101

Mechanical, Electrical & Plumbing Engineer



Date A	pp
	\top
	-
hecked by	
	√D
	Checked by W

Jenness Bathhouse Replacement and Parking Lot Improvements 2280 Ocean Boulevard Rye, New Hampshire 03870

Project Title and Location

Issued for

Construction Documents Issued: June 30, 2016


Project Number
NHBPW
- 80877B

VHB 52348.05

SDA 1535


Drawing Title


Roof Framing Plan

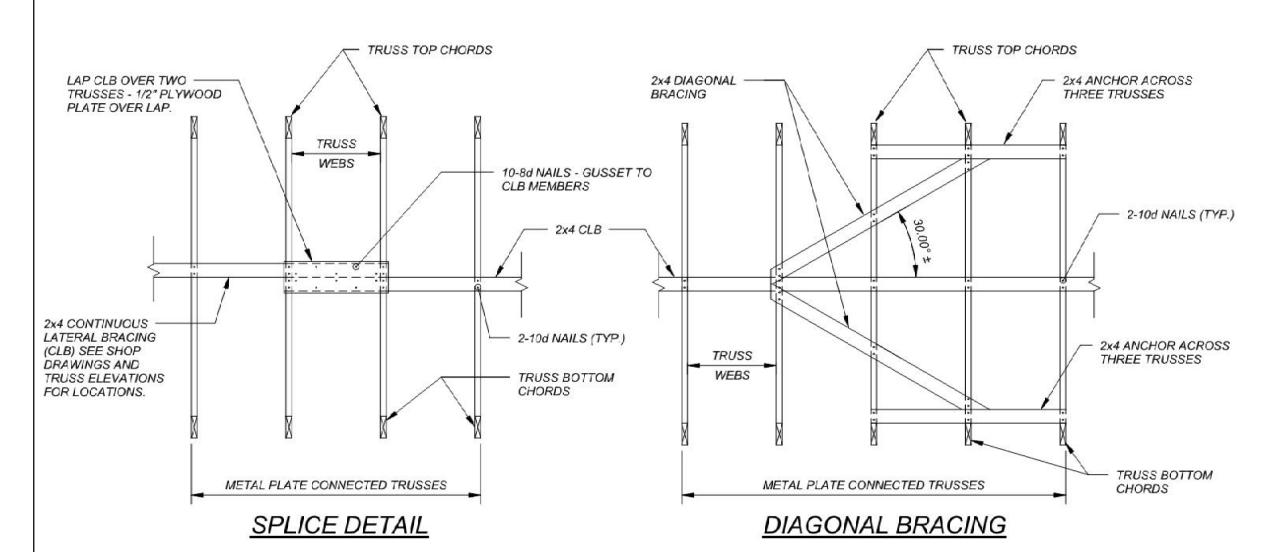


- PROVIDE 1/2" PLYWOOD PLATE OVER LAP SPLICES IN CONTINUOUS LATERAL BRACING (CLB) LINES AS SHOWN.
- PROVIDE DIAGONAL BRACES AND ANCHORS AS SHOWN AT 20'-0" MAXIMUM SPACING ALONG CLB LINES AND AT ENDS OF BUILDING OR TRUSS GROUPS.
- TRUSS WEB MEMBERS TO RECEIVE CONTINOUS LATERAL BRACING SHALL BE DESIGNATED ON THE SHOP DRAWINGS BY THE TRUSS DESIGN ENGINEER AND TAGGED ON THE WEB MEMBERS BY THE TRUSS

CONTINUOUS LATERAL BRACING DETAIL

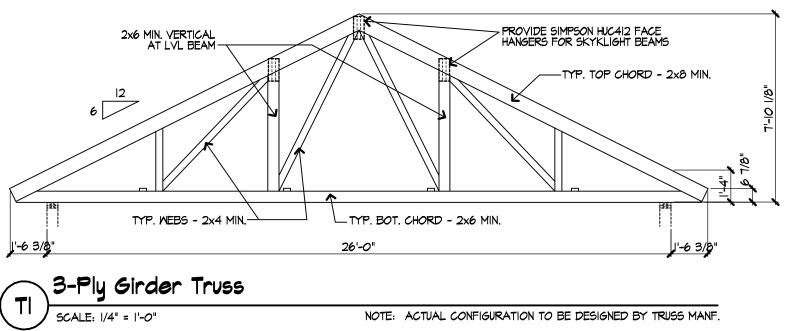

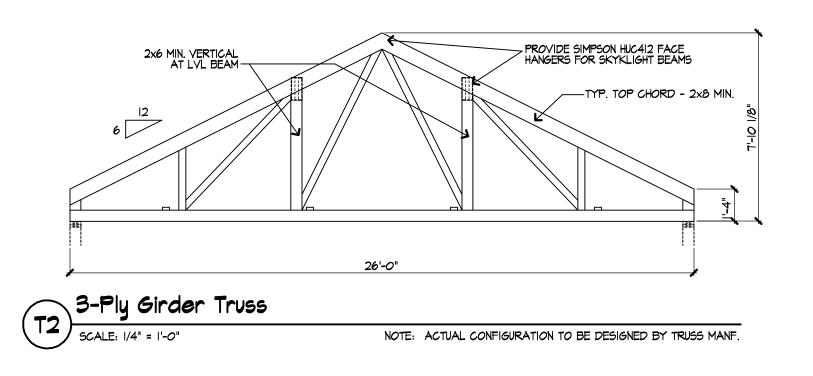

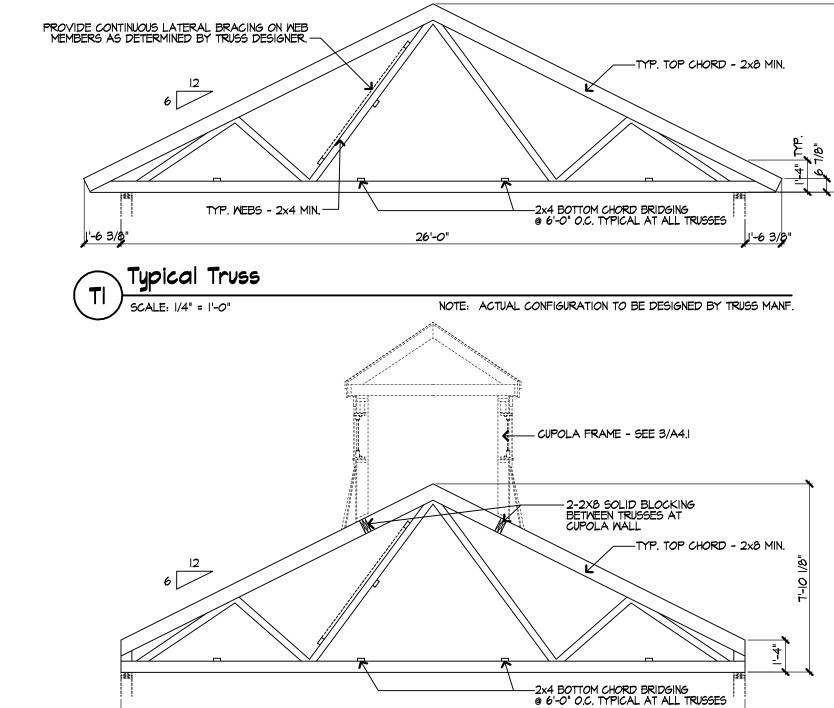

NOTE: ACTUAL CONFIGURATION TO BE DESIGNED BY TRUSS MANF.

METAL PLATE CONNECTED WOOD TRUSSES (SECTION 061753)

METAL PLATE CONNECTED TRUSS NOTES:

1.ALL ROOF TRUSSES SHALL CONFORM TO THE LATEST EDITION OF THE TRUSS PLATE INSTITUTE'S "DESIGN SPECIFICATIONS FOR LIGHT METAL PLATE CONNECTED WOOD TRUSSES" AND SHALL BE DESIGNED FOR THE LOADINGS INDICATED ON THE DRAWINGS OR IN THESE NOTES. TOTAL AND LIVE LOAD DEFLECTIONS SHALL BE LIMITED AS FOLLOWS (UNLESS OTHERWISE INDICATED ON THE DRAWINGS):

LIVE LOAD DEFLECTION: < L/480 TOTAL LOAD DEFLECTION: < L/360

2.FINAL DESIGN OF TRUSSES SHALL BE PROVIDED BY THE DESIGNER/FABRICATOR. SUBMIT COMPLETE SHOP DRAWINGS, CALCULATIONS AND ERECTION PLANS FOR ROOF TRUSSES FOR REVIEW BY THE ARCHITECT. CALCULATIONS SHALL BE PREPARED BY AND BEAR THE STAMP OF A PROFESSIONAL STRUCTURAL ENGINEER, REGISTERED IN THE STATE OF MASSACHUSETTS.

3.ROOF DESIGN LOADS: BASE GROUND SNOW LOAD $P_g = 50$ PSF APPLIED PER IBC 2009 CODE. MINIMUM TRUSS BASIC DESIGN LOADS: TCLL/TCDL/BCLL/BCDL = 39/15/20/10 POUNDS PER SQUARE FOOT (UNLESS NOTED OTHERWISE IN TRUSS ELEVATIONS). GENERÁTE ADDITIONAL LOAD COMBINATIONS AND DESIGN TRUSSES FOR UNBALANCED LOADING (DRIFTING ON ONE SIDE) PER IBC 2009/ASCE 7-05. INCLUDE DETAILED LOAD COMBINATIONS FOR ALL TRUSS CALCULATIONS.

4. WIND DESIGN LOADS ARE AS NOTED IN THE GENERAL NOTES ON SO.1.

5.ALL ROOF TRUSSES MUST BE SECURELY BRACED BOTH DURING ERECTION AND AS REQUIRED AFTER PERMANENT INSTALLATION. INSTALL ALL REQUIRED OR RECOMMENDED TRUSS BRACING SHOWN ON THE STRUCTURAL CONTRACT DRAWINGS, THE TRUSS SHOP DRAWINGS, TPI/WTCA PUBLICATION BCSI 2006 OR AS DIRECTED IN THE FIELD BY THE ARCHITECT/ENGINEER.

6.MINIMUM CHORD SIZES SHALL BE AS SHOWN ON THE TRUSS ELEVATIONS ON THIS DRAWING. MINIMUM WEB MEMBER SIZES SHALL BE 2x4.

7.TRUSS CHORDS AND TRUSS WEB MEMBERS SHALL BE SOUTHERN PINE NO. 2 OR BETTER. ALL LUMBER SHALL BE 19% MAXIMUM MOISTURE CONTENT.

8.TRUSS WEB CONFIGURATIONS SHOWN ON THE TRUSS ELEVATIONS ARE SCHEMATIC. FINAL WEB CONFIGURATIONS SHALL BE DETERMINED BY THE TRUSS DESIGNER/FABRICATOR.

9.PROVIDE SIMPSON "H" SERIES HOLDDOWN CONNECTORS (OR EQUAL) AT ALL TRUSS BEARINGS (INTERIOR AND EXTERIOR BEARING POINTS). TRUSS DESIGNER SHALL SELÈCT AND SPECIFY ON THE TRUSS ERECTION DRAWINGS A HOLDDOWN THAT EXCEEDS THE UPLIFT FORCE PROVIDED IN THE TRUSS SHOP DRAWINGS.

10.TRUSSES SHALL BE SPACED AT 2'-0" ON CENTER.

11.FIELD MODIFICATION OF TRUSSES TO FACILITATE THE INSTALLATION OF MECHANICAL UNITS OR PIPING IS NOT PERMITTED.

12.CONTINUOUS LATERAL BRACING REQUIREMENTS: TOP CHORD: SEE BOTH STRUCTURAL DRAWINGS AND SHOP DRAWINGS FOR UNSHEATHED PORTIONS OF TOP CHORD.


USE THE MORE STRINGENT REQUIREMENT. BOTTOM CHORD: PROVIDE CONTINUOUS LATERAL BRACING OF THE BOTTOM CHORDS OF ALL TRUSSES WITH 2x4 (MIN.) AT 6'-0" o.c. MAX. SPACING. IF GYPSUM SHEATHING IS APPLIED DIRECTLY TO THE BOTTOM CHORD,

BOTTOM CHORD CONTINUOUS LATERAL BRACING MAY BE OMITTED. WEB MEMBERS: SEE THE SHOP DRAWINGS TO IDENTIFY WEB MEMBERS THAT REQUIRE BRACING.

13.DESIGN ALL WEB MEMBERS WITH A LENGTH LESS THAN 8'-0" (FROM WORKING POINT TO WORKING POINT) SO THAT THE WEB MEMBER DOES NOT REQUIRE LATERAL RESTRAINT OR BRACING.


14. WEB TRUSS-TO-TRUSS CONTINUOUS LATERAL BRACING (CLB) SHALL BE DETERMINED BY THE TRUSS DESIGNER. SEE TRUSS SHOPS TO DETERMINE FINAL WEB LAYOUT (SEE NOTE #8) AND PROVIDE CLB AS REQUIRED AND SHOWN ON THE TRUSS SHOPS.


15. CONTINUOUS LATERAL BRACING LINES (CLB) SHALL BE RESTRAINED WITH DIAGONAL, ARROWHEAD OR 'X' BRACING AT EACH END OF CLB LINE AND AT 20'-0" O.C. MAX, PER BCSI 2006 AND THE TYPICAL DETAILS ON THE CONTRACT DRAWINGS. SEE TYPICAL DETAIL ON THIS DRAWING. ALL WEB MEMBERS REQUIRING CLB AS SHOWN ON THE TRUSS SHOPS SHALL RECIEVE ARROWHEAD OR 'X' BRACING.

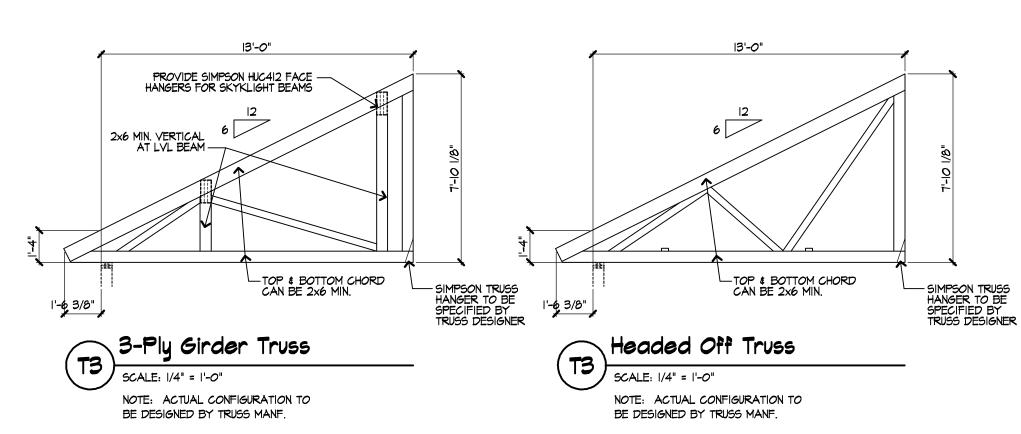

Typical Truss with No Eaves

SCALE: 1/4" = 1'-0"

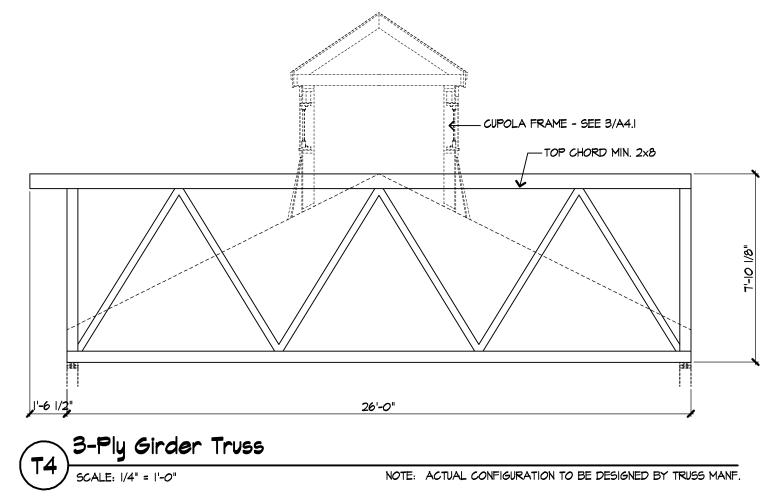

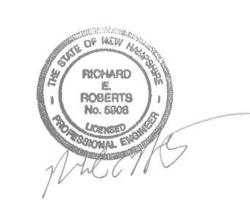



Division of Parks and Recreation New Hampshire **Department of Resources Economic Development**

Administrator

Division of Public Works. Design and Construction

New Hampshire Department of Administrative Services

Civil Engineer / Landscape Architect / Surveyor



SAMYN - D'ELIA ARCHITECTS, P.A (603) 968-7133 / fax: (603) 968-3057 sdarchitects.com

Structural Engineer


T 603-622-4578



F 603-622-4593 www.fbra.com Manchester NH 03101

500 Commercial Street



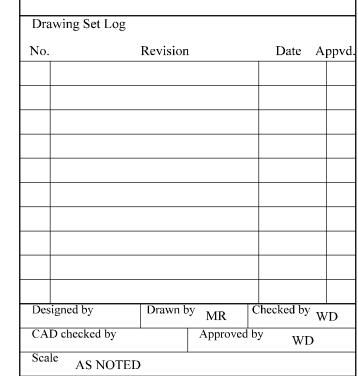

Project Title and Location Jenness Bathhouse Replacement and Parking Lot Improvements

2280 Ocean Boulevard Rye, New Hampshire 03870

Issued for

Construction Documents

Issued: June 30, 2016 Project Number NHBPW - 80877B VHB -52348.05 SDA -1535

Drawing Title


Truss Diagrams & Framing Notes


ELECTRICAL SYMBOLS ABBREVIATIONS ABOVE COUNTER ABOVE FINISHED FLOOR. CIRCUIT BREAKER. GROUND FAULT CIRCUIT INTERRUPTER. GND GROUND. HORSEPOWER. NATIONAL ELECTRICAL CODE. NEC NATIONAL ELECTRICAL MANUFACTURERS ASSOC. NEMA NIC NOT IN CONTRACT. PHOTOELECTRIC SWITCH T.C. TIME CLOCK UNDERGROUND. UG UON UNLESS OTHERWISE NOTED. WEATHER PROOF. WIRING WIRING CONCEALED IN CEILING OR WALLS; SLASH MARKS INDICATE NUMBER OF CONDUCTORS EXCLUDING GROUNDS; CONDUCTOR SIZE AS MARKED; #12 AWG UON. UNDERGROUND CABLE OR DUCT; TYPE, SIZE, CONDUCTORS, AND ARRANGEMENT BY NOTATION OR SCHEDULE. WIRING RUN EXPOSED. **SWITCHES** SWITCH OUTLET; MOUNTED 48" AFF UON; SINGLE POLE UON; LOWER CASE LETTER, WHEN PRESENT, INDICATES OUTLETS CONTROLLED. * ABBREVIATIONS FOR SWITCH OUTLETS 3 3-WAY SWITCH 4 4-WAY SWITCH K KEY OPERATED SWITCH B BURNER SWITCH FT FAN/LIGHT DELAY TIMER SWITCH - FANTECH MODEL FLD60, OR EQUAL DIMMER SWITCH; MOUNTED 48" AFF UON; LOWER CASE LETTER, WHEN PRESENT, INDICATES OUTLETS CONTROLLED. **LIGHTING** FLUORESCENT LIGHT FIXTURE - RECESSED, SURFACE, OR PENDENT MOUNTED RECESSED MOUNTED CEILING FIXTURE INCANDESCENT FIXTURE, WALL SURFACE OR PENDANT MOUNT EXIT SIGN FIXTURE; ARROWS INDICATE REQUIRED SIGN ARROWS. BATTERY POWERED EMERGENCY LIGHTING FIXTURE COMBINATION EMERGENCY LIGHTING FIXTURE ANG EXIT SIGN INDICATES FIXTURE TYPE; SEE SCHEDULE. RECEPTACLES GROUNDED DUPLEX RECEPTACLE (NEMA 5-20R); MOUNTED 18" AFF UON; NUMBER INDICATES CIRCUIT. GROUNDED QUADRUPLEX RECEPTACLE (NEMA 5-20R); MOUNTED 18" AFF UON. DUPLEX RECEPTACLE ON DEDICATED CIRCUIT SPECIAL PURPOSE RECEPTACLE; LETTER INDICATES TYPE; TYPE DEFINED BY NOTATION OR SCHEDULE; MOUNTED 18" AFF UON. PANELS AND MISC. LIGHT OR POWER PANEL FSS FUSED SAFETY (DISCONNECT) SWITCH □ H_{NFSS} NON-FUSED SAFETY (DISCONNECT) SWITCH JUNCTION BOX

MOTOR


LED DRIVER

MOTOR OPERATED DAMPER

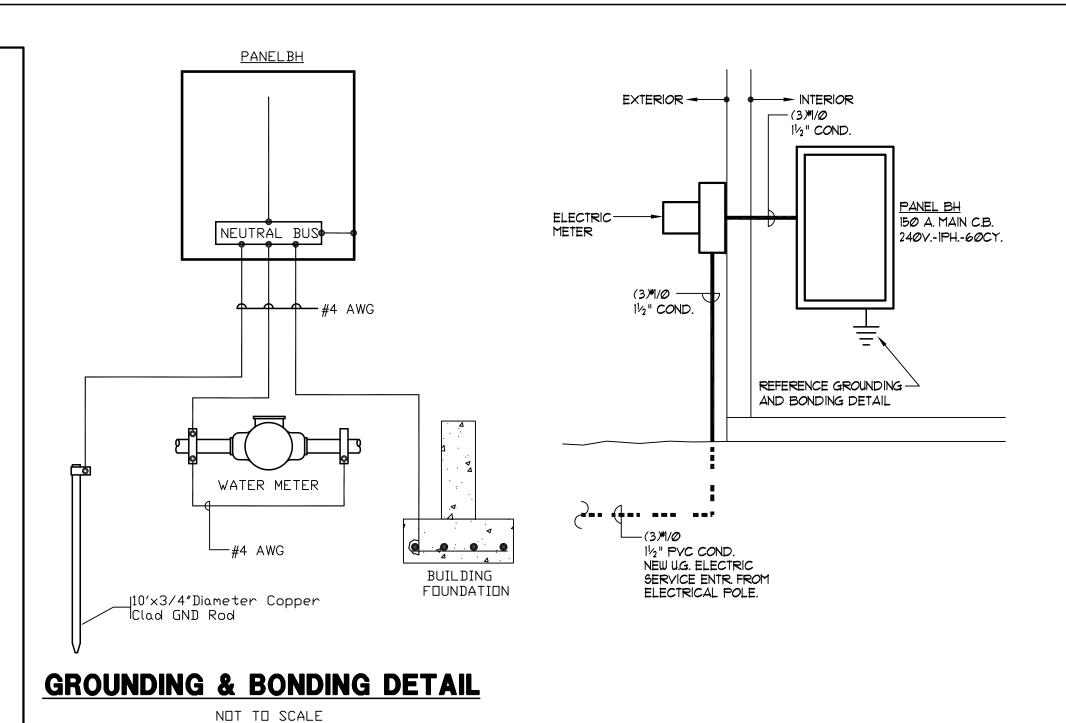

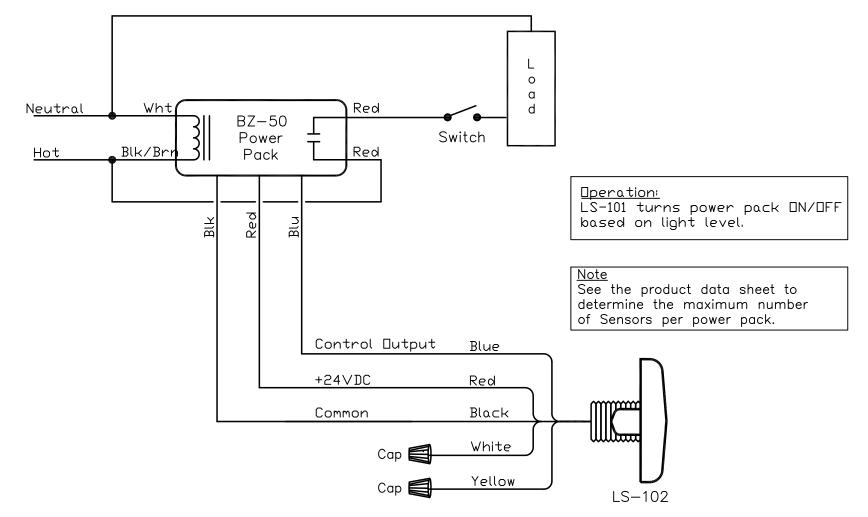

WATTSTOPPER LIGHTSAVER LS-102 SWITCHING PHOTOCELL WIRING DIAGRAM NOT TO SCALE

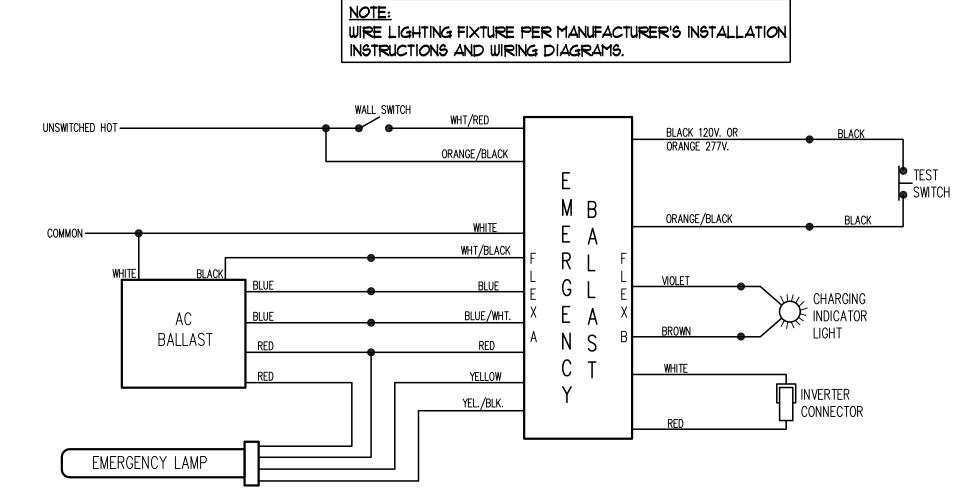

TYPICAL WIRING OF LIGHT FIXTURE WITH


EMERGENCY BALLAST/BATTERY

NOT TO SCALE

FIXTURE TYPE	MOUNTING	MANUFACTURER	CATALOG NO.	NO. OF LAMPS	LAMPING	BF	VOLTS	COLOR	REMARKS/NOTES
LA	SURFACE	LUMINAIRE	√PF4-25W-4 <i>000</i> K-120-CP-WHT-6T/6C-WET	1	25 W. LED	1	120	WHITE	WET LOCATION RATED.
LAE	SURFACE	LUMINAIRE	∨PF4-25W-4000K-120-CP-WHT-6T/6C-WET-EMB20R	1	25 W. LED	1	120	WHITE	EMERGENCY BATTERY PACK WET LOCATION RATED.
LB	RECESSED CEILING	LITHONIA	LDNG-40-20-LD6-WR-120	1	61 W. LED 2 <i>000</i> LUMENS	1	120	WHITE	WET LOCATION RATED.
LBE	RECESSED CEILING	LITHONIA	LDNG-40-20-LD6-WR-120	1	61 W. LED 2000 LUMENS	1	120	WHITE	EMERGENCY BATTERY PACK WET LOCATION RATED.
LC	RECESSED CEILING	LITHONIA	LDNG-40-20-LW6-WR-120-EL	1	61 W. LED 2000 LUMENS	1	120	WHITE	WET LOCATION RATED.
LD	COVE	TOKI-STAR	(2)L6W-3Ø-WH-HB-9'-Ø"	LED	LED 6500 K	NA	8VDC	NΑ	MOUNT ON TOP OF COVE FACING UP
LD- DRIVER	SURFACE	TOKI-STAR	8VDC/8Ø	NΔ	NA	NA	12Ø	NA	MOUNTING IN MECH 103 ON WALL AT CEILING
LEX	WALL OR CEILING	LITHONIA	LQM 9W3 R 120/277 ELN	1	LED	NA	12Ø	WHITE	NI-CAD BATTERY
LE	WALL	SHAPER	673-16-WP-L4/840-120-BM	1	LED 3 <i>000</i> LUMENS 29 W.	NA	120	NATURAL BRONZE	MOUNT TO WOOD BLOCKING PER ARCHITECT.
LF	SURFACE	LUMINAIRE	∨PF2-15W-4 <i>000</i> K-120-CP-WHT-ST/SC-WET	1	15 W. LED	1	120	WHITE	WET LOCATION RATED.

(1) ALL EXTERIOR LIGHTING TO HAVE PHOTELECTRIC SWITCH AND TIME CLOCK CONTROL.

	IRCUII	BREAKER PANI	T NO: BH			(FOR 5G QO21755	UARE "D" N B SURGE E	NG PANEL PROVID BREAKER.	PE SQUARE "D" MODEL		
V	DLTS: 12<i>0</i>/24 0	WIRE: 3 KA RMS:	10 KAIC N	NEUTRAL BA	AR: YES	BR	ANCH C	B: BOLT-ON	NEMA TYPE:	1 MF'R: SQUARE D,	G.E., OR SIET	MENS
PI	HASE: 1 R	RATED AMP: 150 MAIN CB	AMP: 15Ø (GROUND BA	R: YES	KE	Y LOCK:	YES	MOUNTING: SU	IRFACE		
/OLT-AN	MPS(V—A) B	CIRCUIT DESCRIPTION	CONDUCTOR	POLES	C.B.	CK'T#	C.B.	POLES	CONDUCTOR	CIRCUIT DESCRIPTION	VOLT-AM A	IPS(V-A) B
1250		HAND DRYER	2#1Ø+#1ØG.	1	2Ø	1 2	2Ø	1	2#12+#12G.	HAND DRYER	1250	$\backslash\!\!\!/$
><	1250	HAND DRYER	2#1Ø+#1ØG.	1	20	3 4	20	1	2#12+#12G.	RECEPTACLE	$\left\langle \right\rangle$	1000
1250		HAND DRYER	2#1Ø+#1ØG.	1	20	5 6	20	1	2#12+#12G.	RECEPTACLE	1000	$\Big igg /$
><	1250	HAND DRYER	2#12+#12G.	1	20	7 8	2Ø	1	2#12+#12G.	EF-1	$\left\langle \right\rangle$	1000
1250		HAND DRYER	2#12+#12G.	1	20	9 10	2Ø	1	2#12+#12G.	LIGHTING - INTERIOR	900	\bigwedge
><	1250	HAND DRYER	2#12+#12G.	1	20	11 12	2Ø	1	2#1Ø+#1ØG.	LIGHTING - EXTERIOR	$\bigg \backslash \bigg \backslash$	600
22 5 Ø		WATER HEATER WH-1	3#Ø+#ØG.	2	30	13 14	2Ø	1	2#12+#12G.	RECEPT. & DF-1	1000	$\Big igwedge$
><	225Ø	HAND DRYER	2#12+#12G.	1	20	15 16	2Ø	1	2#8+#1ØG.	LIGHTING - SITE	$\bigg \backslash \! \bigg \backslash$	600
		SPACE				17 18				SPACE		\mathbb{X}
><		SPACE				19 20				SPACE	$\bigg \backslash \! \bigg \backslash$	
		SPACE				21 22				SPACE		\mathbb{X}
> <		SPACE				23 24				SPACE	\bigvee	
		SPACE				25 26				SPACE		>>
> <		SPACE				27 28				SPACE	\bigvee	
		SPACE				29 30				SPACE		> <
6200	6000	⊸ T□TAL	TO.	TAL CONN	ECTED	LOAD:	20850	V-A (86.8A	(,)	TOTAL ─►	4700	4150

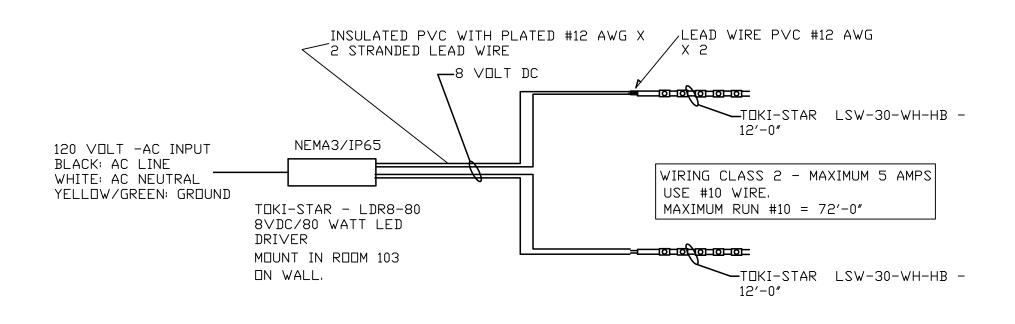

TYPE LD CUPOLA LIGHTING WIRING DIAGRAM
NOT TO SCALE



Division of Parks and Recreation
New Hampshire

Department of Resources and Economic Development

Administrator

Division of Public Works,
Design and Construction
New Hampshire
Department of
Administrative Services

Civil Engineer / Landscape Architect / Surveyor



2 Bedford Farms Drive Suite 200 Bedford, NH 03110 603.391.3900

chitect

SAMYN • D'ELIA

ARCHITECTS, P.A.

ARCHITECTS, P.A.

20 Main Street, Ashland, NH 03217

(603) 968-7133 / fax: (603) 968-3057

sdarchitects.com

Structural Engineer



Mechanical, Electrical & Plumbing Engineer



No.		Revision	l	Date	App
Designed by	CPB	Drawn b	CPB	Checked by	CPI
CAD check	ed by CF	PB	Approved	d by CPB	
Scale AS	NOTED				

Jenness Bathhouse Replacement and Parking Lot Improvements

2280 Ocean Boulevard Rye, New Hampshire 03870

Issued for

Construction Documents
ISSUED: June 30, 2016

Project Number


NHBPW - 80877B

B CHARLES P.
BUCKLEY
NO. 09198


ELECTRICAL
SCHEDULES,
SYMBOLS
AND DETAILS

Drawing Number


E-1

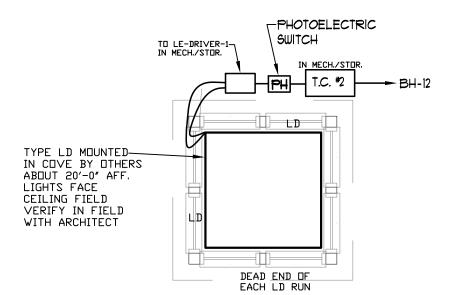

CUPOLA LIGHTING PLAN

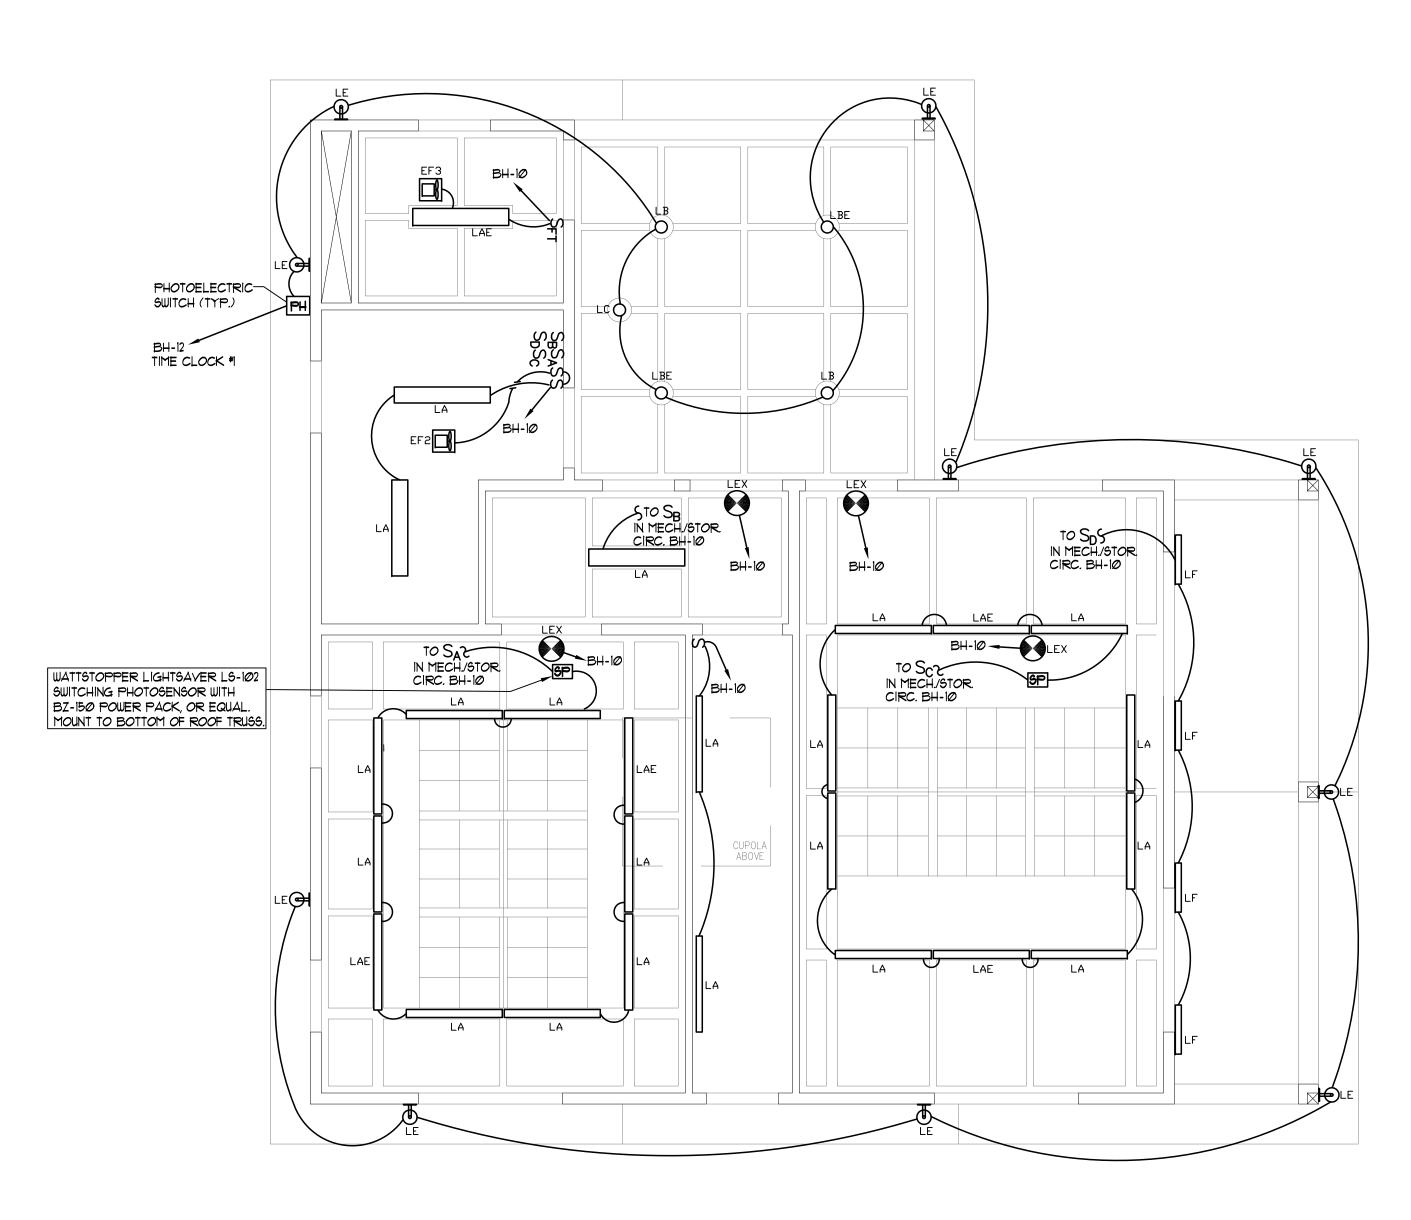



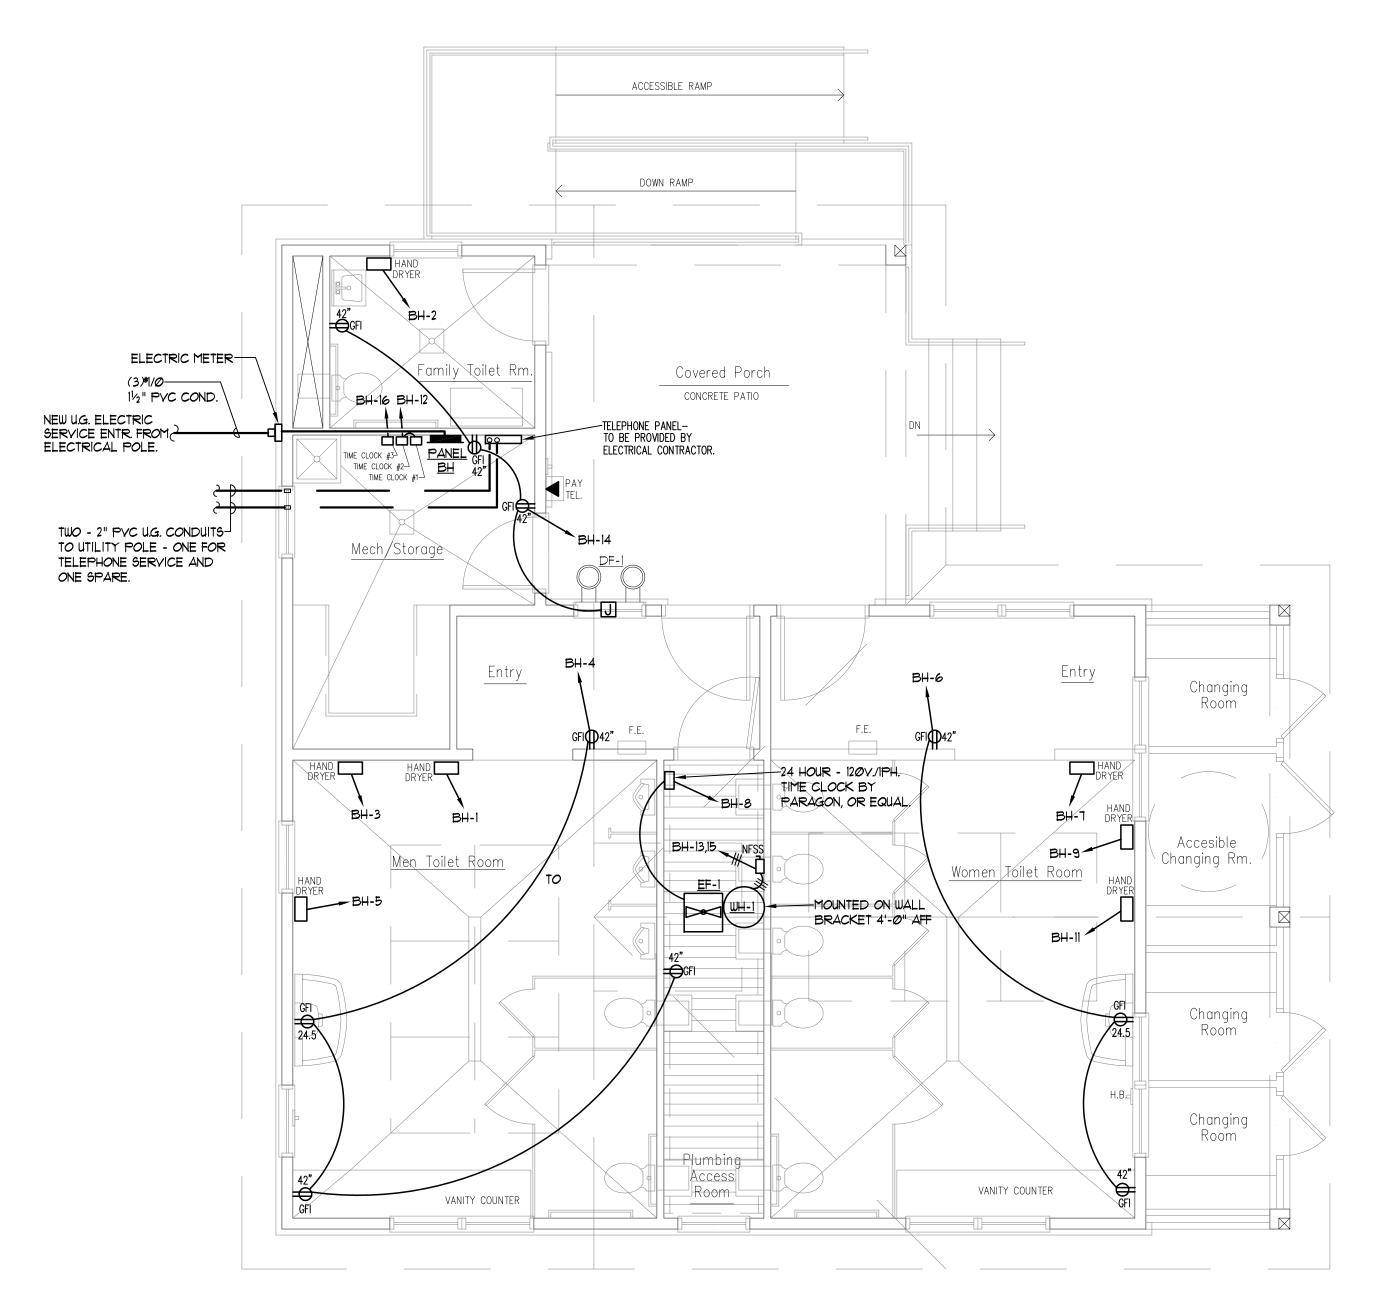

ELECTRICAL POWER PLAN

SCALE: 1/4" = 1'-0"

RESOURCE STATE OF THE SOURCE STATE OF THE SOUR

Division of Parks and Recreation
New Hampshire

Department of Resources and Economic Development

Administrator

Division of Public Works,
Design and Construction
New Hampshire
Department of

Administrative Services

Civil Engineer / Landscape Architect / Surveyor



2 Bedford Farms Drive Suite 200 Bedford, NH 03110

603.391.3900

SAMYN → D'ELIA ARCHITECTS, P.A. 20 Main Street, Ashland, NH 03217 (603) 968-7133 / fax: (603) 968-3057 sdarchitects.com

Structural Engineer



Mechanical, Electrical & Plumbing Engineer



Drawing Set Log

No. Revision Date Appvd.

Designed by CPB Drawn by CPB Checked by CPB

CAD checked by CPB Approved by CPB

Scale AS NOTED

Jenness Bathhouse Replacement and Parking Lot Improvements

2280 Ocean Boulevard Rye, New Hampshire 03870

Issued for

Construction Documents
ISSUED: June 30, 2016

Project Number

NHBPW - 80877B

Project Title and Location

CHARLES P.
BUCKLEY
NO. 09198


RICAI


Drawing Title

ELECTRICAL PLANS

Drawing Number

E - 2

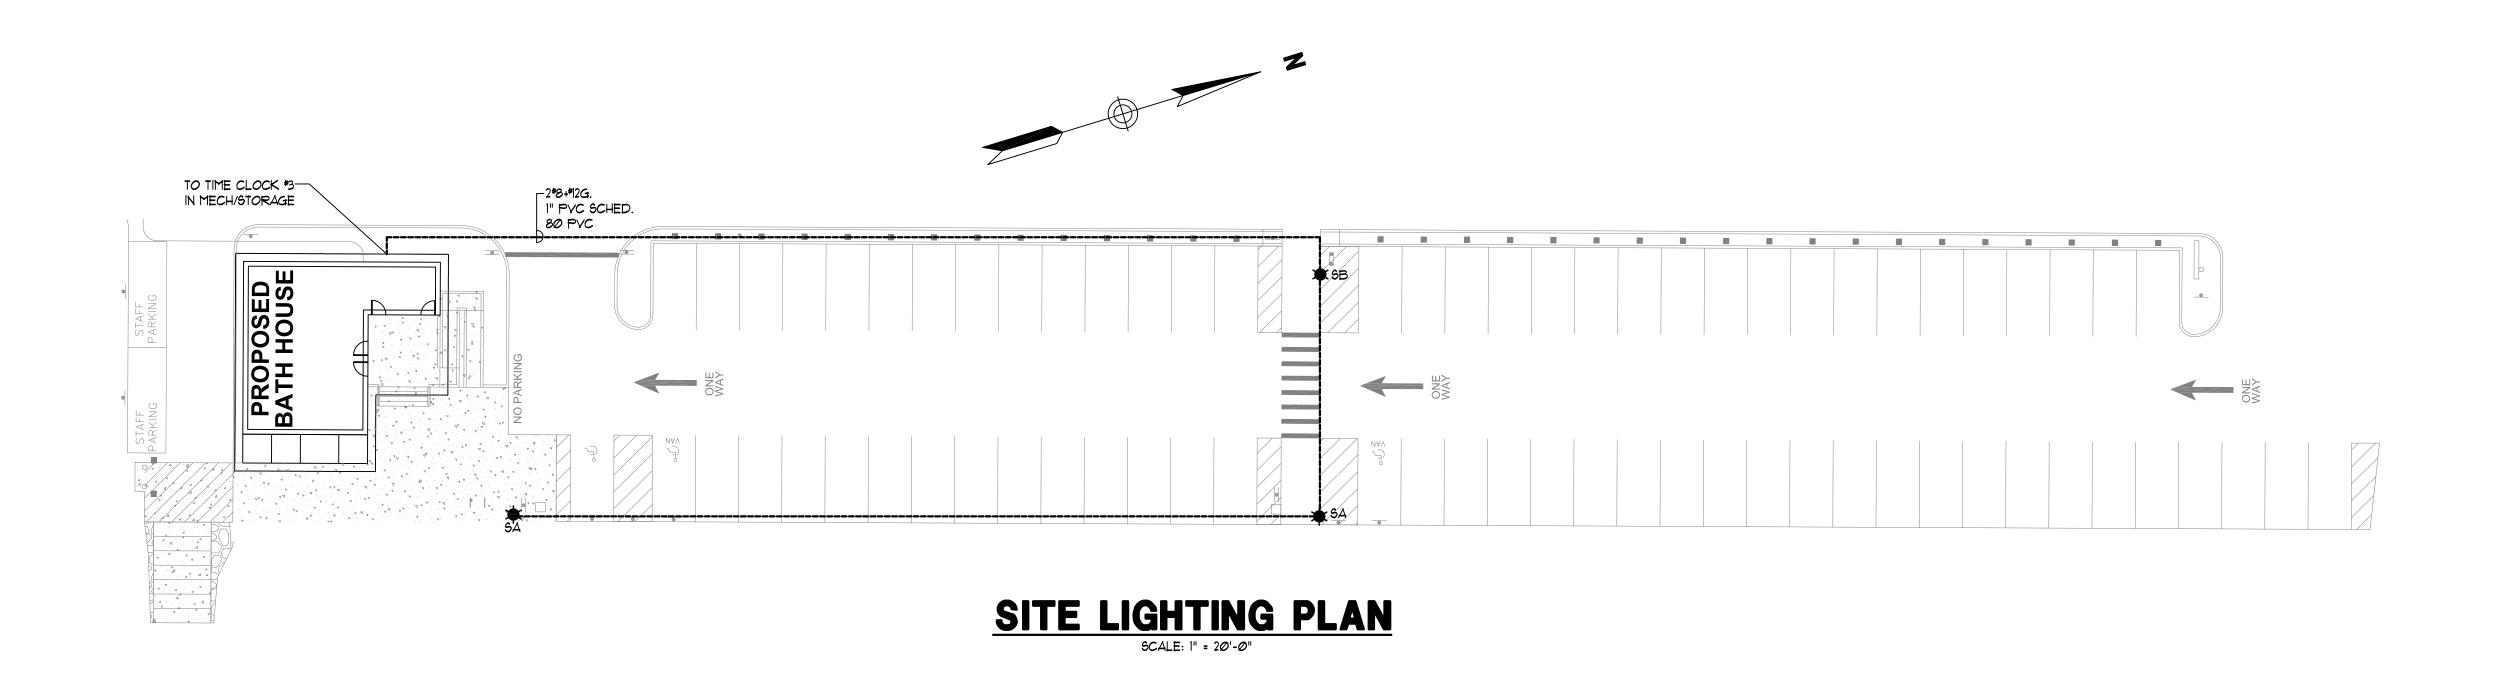

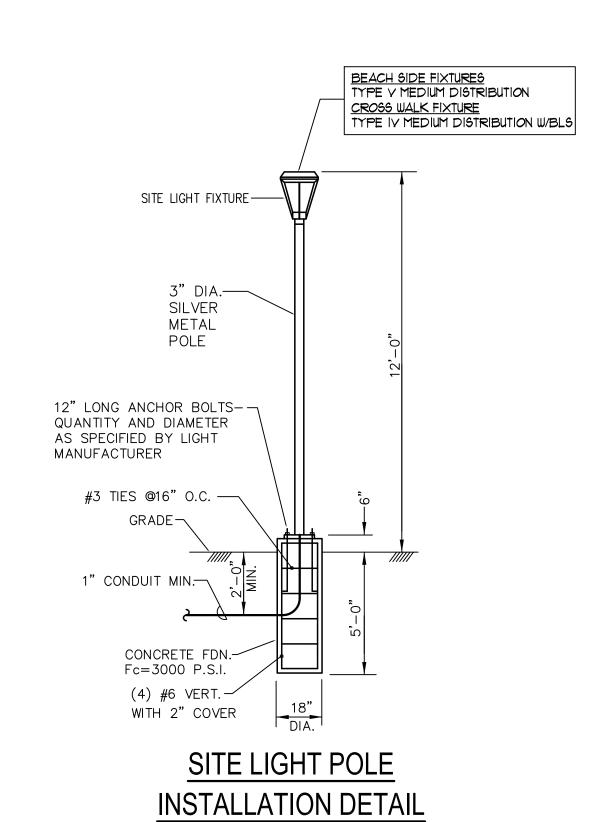

NOT TO SCALE

FIXTURE TYPE	MOUNTING	MANUFACTURER	CATALOG NO.	NO. OF LAMPS	LAMPING	BF	VOLTS	COLOR	REMARKS/NOTES
SA	POLE	CREE	ARE-EDR-5M-R3-Ø4-E-UL-6V-35Ø-P	1	LED-4498 LUMENS	=	120	SILVER	TYPE V MEDIUM DISTRIBUTION PHOTOCELL COLOR: SILVER
SB	POLE	CREE	ARE-EDR-5M-R3-Ø4-E-UL-6V-35Ø-P	1	LED-4498 LUMENS	=	120	SILVER	TYPE IV MEDIUM DISTRIBUTION W/BLS PHOTOCELL COLOR: SILVER



and Recreation New Hampshire Department of Resources and Economic Development

Administrator

Division of Public Works, **Design and Construction** New Hampshire Department of Administrative Services

Civil Engineer / Landscape Architect / Surveyor



2 Bedford Farms Drive

SAMYN • D'ELIA ARCHITECTS, P.A.

20 Main Street, Ashland, NH 03217 (603) 968-7133 / fax: (603) 968-3057 sdarchitects.com

Structural Engineer



Mechanical, Electrical & Plumbing Engineer



Drawing Set Log

No.		Revision	1	Date	Ap	Ŋ
						_
						_
						_
	signed by CPB	Drawn b	CPB	Checked b	y Cl	P
	D checked by CF	РВ	Approved	l by CPB		
Sca	^{le} AS NOTED					

Project Title and Location

Jenness Bathhouse Replacement and Parking Lot Improvements

2280 Ocean Boulevard Rye, New Hampshire 03870

Issued for

Construction Documents ISSUED: June 30, 2016

Project Number NHBPW - 80877B

CHARLES P. BUCKLEY NO. 09198

Drawing Title

SITE ELECTRICAL PLAN & DETAILS

Drawing Number

E-3

HVAC NOTES

1. <u>SCOPE OF WORK</u>

- A. THE CONTRACTOR IS RESPONSIBLE FOR ALL WORK, MATERIALS, AND LABOR TO SATISFY A COMPLETE WORKING SYSTEM WHETHER SPECIFIED OR IMPLIED.
- B. ALL WORK IS TO BE PERFORMED IN STRICT COMPLIANCE WITH THE INTERNATIONAL MECHANICAL CODE 2009, ALL LOCAL AND ALL OTHER REGULATION GOVERNING WORK OF THIS NATURE.
- C. THE CONTRACTOR SHALL, BEFORE SUBMITTING ANY PROPOSAL, EXAMINE THE PROPOSED SITE AND SHALL DETERMINE FOR HIMSELF THE CONDITIONS THAT MAY EFFECT THE WORK, NO ALLOWANCE SHALL BE MADE IF THE CONTRACTOR FAILS TO MAKE SUCH EXAMINATIONS.
- D. ALL EQUIPMENT AND MATERIALS SHALL BE AS SPECIFIED OR "APPROVED EQUAL" BY THE ENGINEER OR ARCHITECT.

2. <u>PERMITS</u>

A. THE CONTRACTOR SHALL SECURE ALL PERMITS OR APPLICA-TIONS AND PAY ANY AND ALL FEES.

3. <u>SHOP DRAWINGS</u>

A. SUBMIT MATERIAL LIST AND SHOP DRAWINGS FOR MAJOR EQUIPMENT TO THE ACHITECT/ENGINEER FOR APPROVAL. THE CONTRACTOR SHALL SUBMIT FIVE SETS OF SHOP DRAWINGS AND THEY SHALL BE CLEARLY LABELED.

4. <u>DUCTWORK</u>

- L

- A. THE DUCTWORK SHALL BE CONSTRUCTED IN ACCORDANCE WITH THE "SMACNA" APPLICABLE MANUALS. ALL DUCTWORK SHALL BE THE LOW VELOCITY TYPE, UNLESS SPECIFIED OTHERWISE.
- B. SMOOTH TURN RADIUS DUCTWORK OR TURNING VANES SHALL BE USED THROUGHOUT WHERE FLOW EXCEEDS 150 CFM.
- C. ALL DUCT JOINTS TO BE SEALED IN ACCORDANCE WITH "SMACNA" STANDARDS AND ACCEPTED GOOD PRACTICE.
- D. ALL DUCT DIMENSIONS SHOWN ARE NET INSIDE VALUES. DIMENSIONS MAY BE CHANGED SO LONG AS THE NET FREE FACE AREA IS MAINTAINED.

DUCTWORK SYMBOLS

5. <u>ELECTRICAL</u>

A. CONTRACTOR TO COORDINATE WITH ELECTRICAL CONTRACTOR FOR LOCATION OF WIRING FOR EACH HVAC UNIT.

MISCELLANEOUS

- A. COORDINATE INSTALLATION OF ALL ROOF FLASHING AT ROOF PENETRATION.
- B. DO NOT SCALE THIS DRAWING FOR EXACT DIMENSIONS. VERIFY ALL FIGURES, CONDITIONS, AND DIMENSIONS AT THE JOB SITE.
- C. THE MECHANICAL PLANS ARE INTENDED TO BE DIAGRAM-MATIC AND ARE BASED ON ONE MANUFACTURE'S EQUIP-MENT. THEY ARE NOT INTENDED TO SHOW EVERY ITEM IN ITS EXACT LOCATION, THE EXACT DIMENSIONS, OR ALL THE DETAILS OF THE EQUIPMENT. THE CONTRACTOR SHALL VERIFY THE ACTUAL DIMENSIONS OF THE EQUIP-MENT PROPOSED TO ENSURE THAT THE EQUIPMENT WILL FIT IN THE AVAILABLE SPACE.

TESTING AND BALANCING


A. THE HVAC SYSTEM SHALL BE TESTED AND AND BALANC-ED BY AN INDEPENDENT AGENCY, UNDER THE SUPER-VISION OF A LICENSED PROFESSIONAL ENGINEER, A SEALED TYPE WRITTEN REPORT SHALL BE SUBMITTED TO THE ARCHITECT/ENGINEER FOR REVIEW AND APPROVAL.

<u>GUARANTEE</u>

- A. MATERIALS, EQUIPMENT AND INSTALLATION SHALL BE GUARANTEED FOR A PERIOD OF ONE(1) YEAR FROM DATE OF ACCEPTANCE. DEFECTS WHICH APPEAR DURING THAT PERIOD SHALL BE CORRECTED AT THIS CONTRACTOR'S
- B. FOR THE SAME PERIOD, THE MECHANICAL CONTRACTOR SHALL BE RESPONSIBLE FOR ANY DAMAGE TO PREMISES CAUSED BY DEFECTS IN WORKMANSHIP OR IN THE WORK OR EQUIPMENT FURNISHED AND/OR INSTALLED BY HIM.


9. <u>WRITTEN SPECIFICATIONS</u>

A. REFERENCE MECHANICAL WRITTEN SPECIFICATIONS FOR COMPLETE DESCRIPTION OF THE VENTILATION SYSTEM.

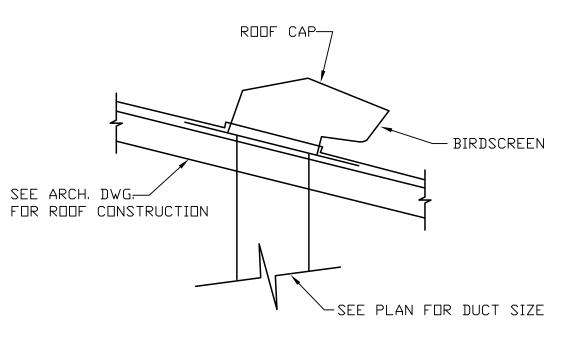

ROOF CAP DETAIL NOT TO SCALE


(EF-2 AND EF-3)

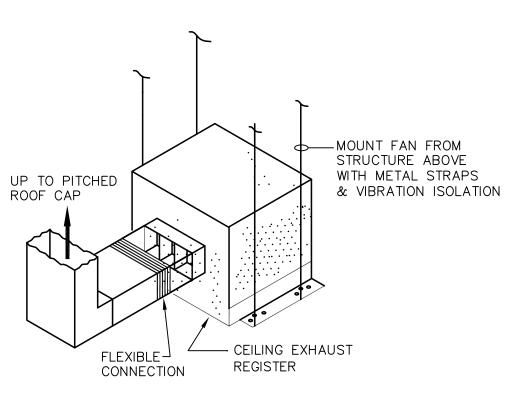


CEILING EXHAUST FAN DETAIL

(EF-2 AND EF-3)

NOT TO SCALE

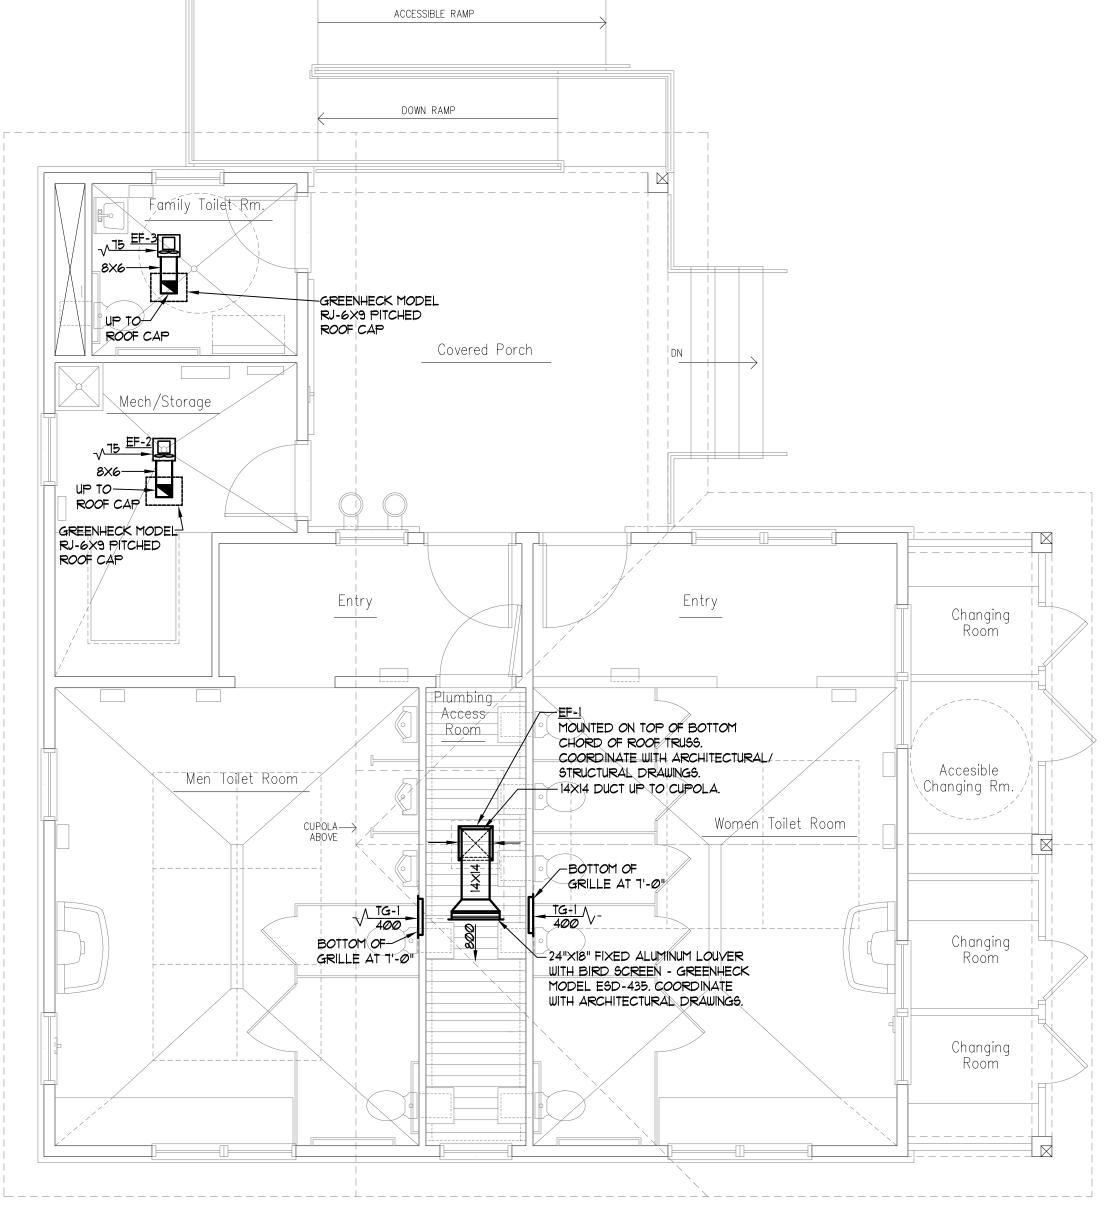

VENTILATION PLAN

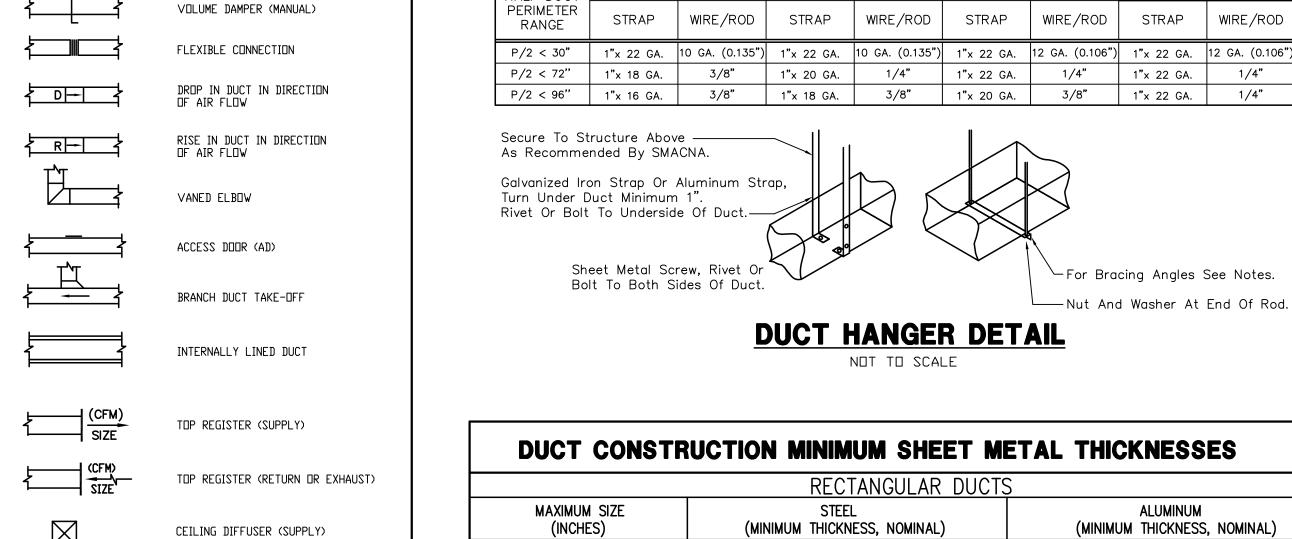

CEILING DIFFUSER (RETURN OR EXHAUST)

LOUVER

NAINGE		'		,		·		
P/2 < 30"	1"x 22 GA.	10 GA. (0.135")	1"x 22 GA.	10 GA. (0.135")	1"x 22 GA.	12 GA. (0.106")	1"x 22 GA.	12 GA. (0.106
P/2 < 72"	1"x 18 GA.	3/8"	1"x 20 GA.	1/4"	1"x 22 GA.	1/4"	1"x 22 GA.	1/4"
P/2 < 96"	1"x 16 GA.	3/8"	1"x 18 GA.	3/8"	1"x 20 GA.	3/8"	1"x 22 GA.	1/4"
Turn Under D Rivet Or Bolt	on Strap Or Ouct Minimum	Aluminum Str 1 1".	ap,					
		rew, Rivet Or	\vee \vee					

RECTANGULAR DUCT HANGER SCHEDULE (MINIMUM SIZES)


PAIR AT 10' SPACING PAIR AT 8' SPACING PAIR AT 5' SPACING PAIR AT 4' SPACING


DUCT HANGER DETAIL

Nut And Washer At End Of Rod.

NOT TO SCALE

DUCT CONSTR	RUCTION MINIMUM SHEET N	METAL THICKNESSES
	RECTANGULAR DUC	TS
MAXIMUM SIZE (INCHES)	STEEL (MINIMUM THICKNESS, NOMINAL)	ALUMINUM (MINIMUM THICKNESS, NOMINAL)
THROUGH 12 13 THROUGH 30 31 THROUGH 54 55 THROUGH 84 OVER 84	0.022 INCH (26 GAGE, GALV.) 0.028 INCH (24 GAGE, GALV.) 0.034 INCH (22 GAGE, GALV.) 0.040 INCH (20 GAGE, GALV.) 0.052 INCH (18 GAGE, GALV.)	0.020 INCH (NO. 24 B&S GAGE) 0.025 INCH (NO. 22 B&S GAGE) 0.032 INCH (NO. 20 B&S GAGE) 0.040 INCH (NO. 18 B&S GAGE) 0.051 INCH (NO. 16 B&S GAGE)

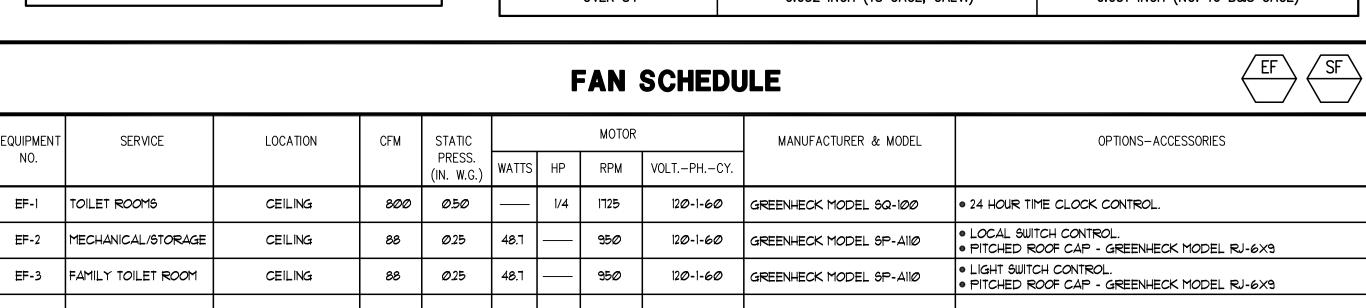

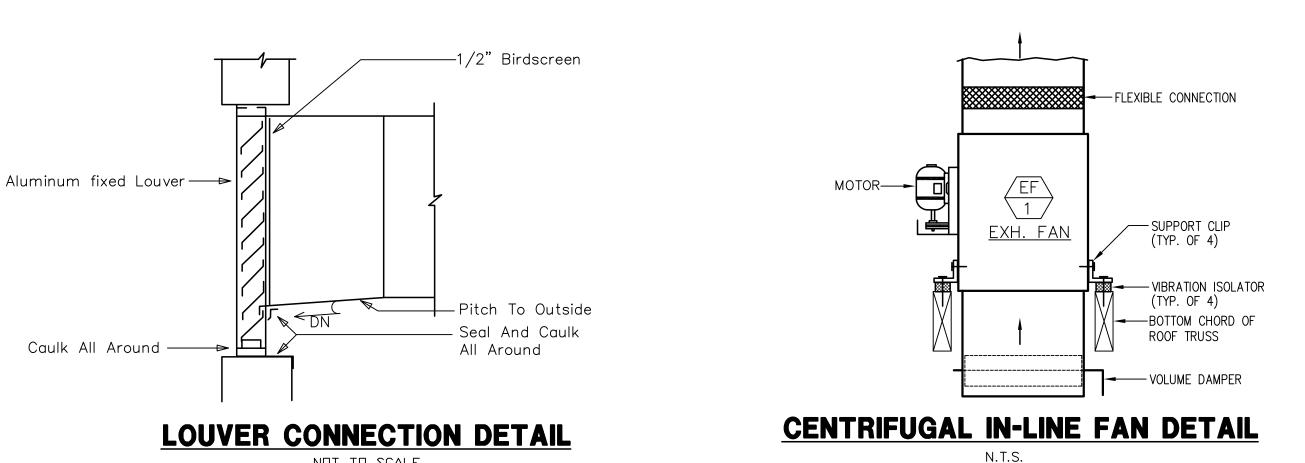

		GRILLE - REGISTER - DIFFUSER SCHEDULE									
	SR-SUPPLY REGISTER	RG-RETUI	RN GRILLE	CD-CEILING DIFFUSER	EG-EXHAUST G	TG-TRANSFER GRILLE					
EQUIPMENT NO.	SIZE	TYPE	MANUFA	CTURER & MODEL	FINISH	OPTIONS-ACCESSORIES					
TG-1	24"XI8"	TRANSFER GRILLE	HART & COO	LEY MODEL RH45 - 24"XI8"	WHITE						


NOT TO SCALE

Division of Parks and Recreation New Hampshire Department of Resources and **Economic Development**

Division of Public Works. Design and Construction

New Hampshire Department of Administrative Services

Civil Engineer / Landscape Architect / Surveyor

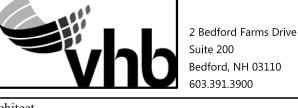

SAMYN - D'ELIA ARCHITECTS, P.A 20 Main Street, Ashland, NH 0321 (603) 968-7133 / fax: (603) 968-3057

sdarchitects.com

Structural Engineer



Mechanical, Electrical & Plumbing Engineer



No.		Revision	l		Date	A	ppv
				T			Ì
				+			
				-			
				_			
Designed by	CPB	Drawn b	CPB		necked by	C	PE
CAD check	Cl	PB	Approved	l by	СРВ		
Scale AS	NOTED)					


Project Title and Location

Jenness Bathhouse Replacement and Parking Lot Improvements

2280 Ocean Boulevard Rye, New Hampshire 03870

Construction Documents ISSUED: June 30, 2016

NHBPW - 80877B

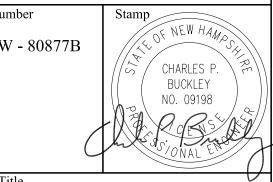


Drawing Title **MECHANICAL** PLAN AND **DETAILS**

Drawing Number

M - 1

	PLUMBING S	SYMBOLS	
<u>SYMBOL</u>	<u>DESCRIPTION</u>	SYMBOL	<u>DESCRIPTION</u>
	SOIL OR WASTE PIPE (BELOW GROUND)	<u></u>	VACUUM BREAKER
	SOIL OR WASTE PIPE (ABOVE GROUND)	\oslash	PRESSURE GAGE
	VENT PIPE (V)		TEMPERATURE GAGE
	COLD WATER PIPE (CW)	<u> </u>	WATER METER
	HOT WATER PIPE (HW)	⊸ \$—	PRESSURE REDUCING VALVE
	- HOT WATER RETURN (HWR)	$\overline{}$	GAS COCK
G	NATURAL GAS PIPE	VTR	VENT THROUGH ROOF
SD	STORM DRAIN PIPE	LAV	LAVATORY
	FLOOR DRAIN	WC	WATER CLOSET
—0 со	CLEAN-OUT(FLOOR)	URN	URINAL
—— ı co	CLEAN-OUT(WALL)	DF	DRINKING FOUNTAIN
WH	HOT WATER HEATER	A.D.	ACCESS DOOR
	BALL VALVE	U.G.	UNDERGROUND
- 1∕1ø-	CHECK VALVE		
- ∕ Ø- \$ -	TEMP./PRESS. RELIEF VALVE		
_ -	FIXTURE ISOLATION VALVE		

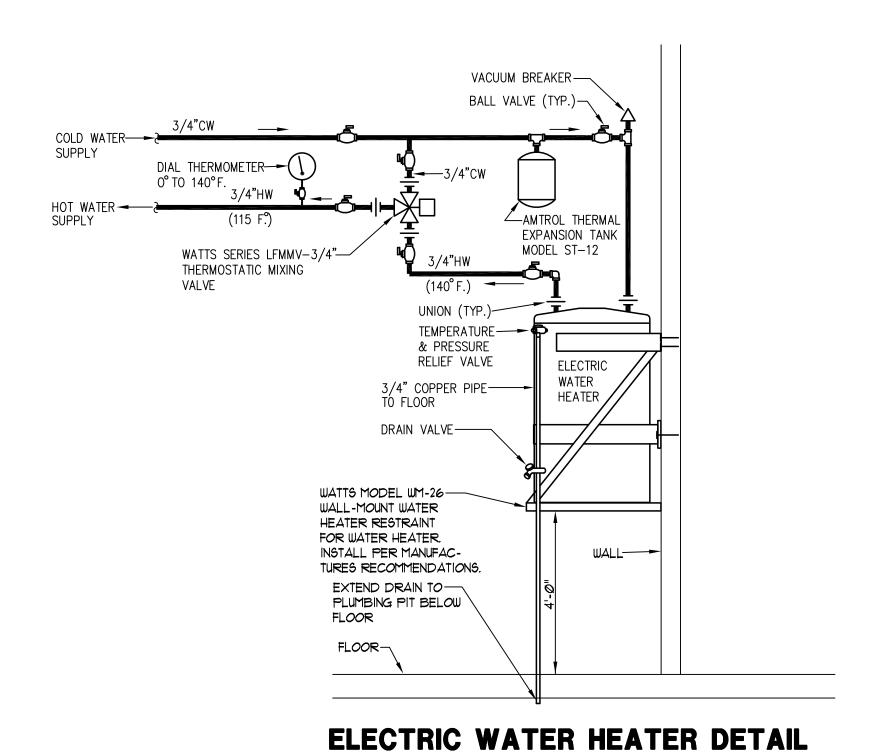

		ELECTRIC WATER HEATER SCHEDULE											
ITEM NO.	CAPACITY	RECOVERY @90 DEG. F. RISE	HEATING ELEMENT KW	ELECTRIC V./PH.	WATER CONN.	MANUFACTURER & MODEL	REMARKS						
WH-1	30 GAL.	20 GPH	45	24Ø/l	3/4"	RHEEM MARATHON MODEL MR30245	• 140°F. DISCHARGE TEMPERATURE						

PLUMBING NOTES

- 4. <u>SANITARY/STORM DRAINAGE AND VENT PIPING</u>
- A. THE CONTRACTOR IS RESPONSIBLE FOR ALL WORK, MATERIALS, AND LABOR TO SATISFY A COMPLETE WORKING SYSTEM WHETHER SPECIFIED OR IMPLIED.
- B. ALL WORK IS TO BE PERFORMED IN STRICT COMPLIANCE WITH THE NATIONAL STANDARD PLUMBING CODE (2006) AND UNIFORM CONSTRUCTION CODE (LATEST EDITION).
- C. THE CONTRACTOR SHALL, BEFORE SUBMITTING ANY PROPOSAL, EXAMINE THE PROPOSED SITE AND SHALL DETERMINE FOR HIMSELF THE CONDITIONS THAT MAY EFFECT THE WORK. NO ALLOWANCE SHALL BE MADE IF THE CONTRACTOR FAILS TO MAKE SUCH EXAMINATIONS.
- D. ALL EQUIPMENT AND MATERIALS SHALL BE AS SPECIFIED OR "APPROVED EQUAL" BY ENGINEER OR ARCHITECT.
- SHOP DRAWINGS

FIXTURE

WC-1

WC-2

(A.D.A.)

URN-1

URN-2

(A.D.A.)

(A.D.A.)

MS-1

₩F-1

FD-1

DF-1

(A.D.A.)

TD-1

HB-1

HB-2

SCOPE OF WORK

- A. SUBMIT MATERIAL LIST AND SHOP DRAWINGS FOR MAJOR EQUIPMENT/FIXTURES TO THE ARCHITECT OR ENGINEER FOR APPROVAL. THE CONTRACTOR SHALL SUBMIT SIX SETS OF SHOP DRAWINGS AND THEY SHALL BE CLEARLY LABELED.
- DOMESTIC WATER SUPPLY PIPING
 - A. UNDERGROUND: PROVIDE TYPE "K" SOFT DRAWN COPPER TUBING WITH BRAZED CONNECTIONS, OR POLYETHYLENE TUBING OR SCHED. 40 CPVC WITH CPVC CEMENTED FITTINGS.
 - B. ABOVE GROUND: PROVIDE TYPE "L" HARD DRAWN COPPER TUBING WITH 125 PSI SOLDER JOINTS, COPPER OR BRASS FITTINGS, OR PEX TUBING WITH PEX FITTINGS, OR SCHED. 40 CPVC WITH CPVC CEMENTED FITTINGS.
 - C. ALL HOT WATER PIPING TO BE INSULATED WITH 1" FIBERGLASS INSULATION.
 - D. ALL COLD WATER PIPING TO BE INSULATED WITH 1/2" FOAM INSULATION.
 - E. ALL WATER PIPING SHALL BE INSTALLED SO AS FACILITATE SEASONAL DRAIN DOWN OF THE BUILDING'S WATER SYSTEMS. ALL PIPES SHALL BE PITCHED TO DRAIN BACK TO ACCESSIBLE LOW POINTS WHICH SHALL BE FITTED WITH BOILER DRAIN TYPE TAPS. THERE SHALL BE NO DIPS OR LOW POINTS IN THE WATER SYSTEM PIPING WITHOUT ACCESSIBLE DRAIN BACK TAPS.

DESCRIPTION

AMERICAN STANDARD AFWALL ELONG.

AMERICAN STANDARD AFWALL ELONG.

AMERICAN STANDARD WASHBROOK

FLOWISE 0.5 HIGH EFFICIENCY URINAL

AMERICAN STANDARD WASHBROOK

FLOWISE 0.5 HIGH EFFICIENCY URINAL

AMERICAN STANDARD LUCERNE

FIAT MOLDED-STONE MOP SERVICE

BRADLEY TERREON WALL-HUNG

QUADRA-FOUNT WASHFOUNTAINS

JAY R. SMITH FLOOR DRAIN

ELKAY LEVEL ADA WATER COOLER

JAY R. SMITH 6" WIDE CHANNEL SLOPE JAY R. SMITH

PRECAST POLYMER CONCRETE FLOOR MODEL 9814

WITH WATER REFILLING STATION.

ZURN INTERIOR HOSE BIBB -

ZURN EXTERIOR HOSE BIBB -

ANTI-SIPHON, WALL HYDRANT,

ENCASED WALL HYDRANT.

ANTI-SIPHON, AUTOMATIC DRAINING

AUTOMATIC DRAINING & NON-FREEZE.

WALL-HUNG LAVATORY

BASIN - 24"X24"

FLUSH VALVE TOILET

FLUSH VALVE TOILET

MANUFACTURER

INTE-

GRAL

INTE-

GRAL

INTE-

GRAL

INTE-

11/2"

11/2"

4"

11/2"

11/2"

11/2"

ا^ر 1ا

11/2"

4"

GRAL

& CAT. NO.

AMERICAN STD.

AMERICAN STD.

MODEL 2634.001

AMERICAN STD.

MODEL 6515.005

AMERICAN STD.

MODEL 6515.005

MODEL Ø355.Ø12

FIAT MODEL

MSB 2424

BRADLEY

MODEL MF2949

JAY R. SMITH

MODEL 2010C

ELKAY MODEL

LZSTL8WSLK

(6 FT. LONG)

Z-133Ø-C-CL

Z-1321-C-CW

AMERICAN STD. MODEL

MODEL 2634.001

- A. ABOVE GRADE: -2" AND BELOW: SCH. 40 PVC WITH SOLVENT JOINTS.
- -3" AND ABOVE: SCH. 40 PVC WITH SOLVENT JOINTS.
- B. BELOW GRADE: SCH. 40 PVC WITH SOLVENT
- C. PVC PIPING SHALL NOT BE USED IN AIR PLENUM CEILINGS AND SHALL NOT CROSS FIRE RATED WALLS, CEILINGS, OR FLOORS.
- D. DRAINAGE PIPING SHALL BE RUN AS STRAIGHT AS POSSIBLE AND SHALL HAVE LONG TURN FITTINGS.
- E. DRAINAGE PIPING 3" SIZE AND SMALLER SHALL RUN AT A UNIFORM GRADE OF AT LEAST 1/4" PER FOOT, AND PIPING LARGER THAN 3" SHALL BE RUN AT A GRADE OF NO LESS THAN 1/8" PER FOOT.
- F. CONTRACTOR SHALL BE RESPONSIBLE FOR THE PROPER FLASHING OF THE VENT PIPING RUN THROUGH THE ROOF.
- 5. ALL STUB-INS AND/OR SLAB OR WALL PENETRATION TO BE PER NATIONAL STANDARD PLUMBING CODE. ALL PIPING PENETRATIONS OF BUILDING FOUNDATIONS OR FOOTINGS SHALL BE SLEEVED.

PLUMBING FIXTURE SCHEDULE

PIPING CONNECTIONS
S/W VENT C.W. H.W.

1½"

1/2"

11/2"

3/4"

3/4"

3/4"

3/4"

• COLOR: OAT

12@Y./IPH.

ADJUSTABLE STRAINER

• TRAP PRIMER CONNECTION

• COLOR: STAINLESS STEEL

HORIZONTAL OUTLET 4"

• TRAP PRIMER CONNECTION

PROVIDE WITH CYLINDER LOCK.

• JAY R. SMITH MODEL 9870-450-55 - $3\frac{1}{4}$ " \times $\frac{3}{6}$ " STAINLESS STEEL GRATE

• 4" DEEP SEAL TRAP

WITH WATER REFILLING STATION

• 4" DEEP SEAL TRAP

- A. ABOVE GRADE ALL PIPE SHALL BE SUPPORTED FROM THE BUILDING STRUCTURE IN A NEAT AND WORKMANLIKE MANNER.
- B. BELOW GRADE
- EARTH SHALL BE EXCAVATED TO A MINIMUM DEPTH WITH AN EVEN SURFACE TO INSURE SOLID BEARING OF PIPE FOR ITS ENTIRE LENGTH.
- -INTERIOR: THE PIPE SHALL BE INSTALLED (UNLESS OTHER-WISE SPECIFIED) A MINIMUM OF 4 INCHES BELOW THE BOTTOM OF THE SLAB AND SHALL NOT BE IN ANY DIRECT CONTACT WITH THE CONCRETE AT ANY POINT.

7. MISCELLANEOUS

- A. COORDINATE INSTALLATION OF ALL ROOF FLASHING AT
- B. DO NOT SCALE THIS DRAWING FOR EXACT DIMENSIONS. VERIFY ALL FIGURES, CONDITIONS, AND DIMENSIONS AT THE JOB SITE.
- C. THE PLUMBING PLANS ARE INTENDED TO BE DIAGRAMATIC MATIC AND ARE BASED ON ONE MANUFACTURE'S EQUIP-MENT. THEY ARE NOT INTENDED TO SHOW EVERY ITEM IN ITS EXACT LOCATION, THE EXACT DIMENSIONS, OR ALL THE DETAILS OF THE EQUIPMENT. THE CONTRACTOR SHALL VERIFY THE ACTUAL DIMENSIONS OF THE EQUIP-MENT PROPOSED TO ENSURE THAT THE EQUIPMENT WILL FIT IN THE AVAILABLE SPACE.

A. PLUMBING SYSTEMS SHALL BE FLOW AND PRESSURE TESTED & DISINFECTED IN ACCORDANCE WITH STANDARD PRACTICE AND THE NATIONAL STANDARD PLUMBING CODE.

WRITTEN SPECIFICATIONS

DESCRIPTION OF THE PLUMBING SYSTEMS. REMARKS • FLUSHOMETER VALVE: SLOAN ROYAL MODEL 152-16 • WALL BOX: SLOAN MODEL WB-1-A • FIXTURE SUPPORT: JAY R. SMITH MODEL Ø21Ø • SEAT: CHURCH MODEL 9500C (COLOR: BLACK) • FLUSHOMETER VALVE: SLOAN ROYAL MODEL 152-1.6 • WALL BOX: SLOAN MODEL WB-1-A • FIXTURE SUPPORT: JAY R. SMITH MODEL 0210 • SEAT: CHURCH MODEL 9500C (COLOR: BLACK) • FLUSHOMETER VALVE: SLOAN ROYAL MODEL FLUSHOMETER MODEL 190-1.5 ● WALL BOX: SLOAN MODEL WB-1-A • FIXTURE SUPPORT: JAY R. SMITH MODEL 0636 • FLUSHOMETER VALVE: SLOAN ROYAL MODEL FLUSHOMETER MODEL 190-1.5 • WALL BOX: SLOAN MODEL WB-1-A • FIXTURE SUPPORT: JAY R. SMITH MODEL 0636 • FAUCET: SYMMONS MODEL S-60-H • STOP VALVE: WATTS 889/890 • FIXTURE SUPPORT: JAY R. SMITH MODEL Ø700 • WASTE WITH OPEN STRAINER: KEENEY MANUFACTURING CO. P/N 5700PC • HANDICAPPED PIPE INSULATION: PLUMBEREX HANDY-SHIELD MAXX • FAUCET: FIAT SERVICE FAUCET MODEL 830-AA • HOSE AND HOSE BRACKET - FIAT MODEL 832-AA • MOP HANGER - FIAT MODEL 889-CC • VINYL BUMPER GUARD: FIAT MODEL E-11-AA • YALVE: BRADLEY MODEL TT - TOUCH TIME CONTROL • "LSD" - LIQUID SOAP DISPENSER OPTION

6. <u>PIPE SUPPORTS</u>

THE USE OF WIRE AND PERFORMED METAL TO SUPPORT PIPES WILL NOT BE PERMITTED. SPACING OF PIPE SUPPORTS SHALL BE AS SPECIFIED IN THE NATIONAL STANDARD PLUMBING CODE.

- -EXTERIOR: THE WATER PIPE SHALL HAVE A MINIMUM OF 54" OF COVER AND THE SANITARY WASTE PIPE SHALL HAVE A MINIMUM OF 36" OF COVER.

- ROOF PENETRATION.

8. <u>TESTING AND DISINFECTION</u>

A. REFERENCE PLUMBING WRITTEN SPECIFICATIONS FOR COMPLETE



Department of Resources and **Economic Development**

Administrator

Division of Public Works, **Design and Construction** New Hampshire

Administrative Services

Department of



SAMYN • D'ELIA

ARCHITECTS. P.A. 20 Main Street, Ashland, NH 0321 (603) 968-7133 / fax: (603) 968-3057 sdarchitects.com

Structural Engineer



Mechanical, Electrical & Plumbing Engineer



No.		Revision	1	Date	App
					Ť
					_
					_
Designed by	CPB	Drawn b	у СРВ	Checked by	CP
CAD check	ed by	PB	Approved	Tby CPB	

Jenness Bathhouse Replacement and Parking Lot Improvements


Project Title and Location

2280 Ocean Boulevard Rye, New Hampshire 03870

Issued for

Construction Documents ISSUED: June 30, 2016

Project Number NHBPW - 80877B

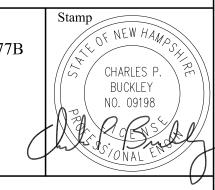


Drawing Title


PLUMBING SYMBOLS, NOTES AND SCHEDULES

Drawing Number

P-1


Sheet 1 of 3

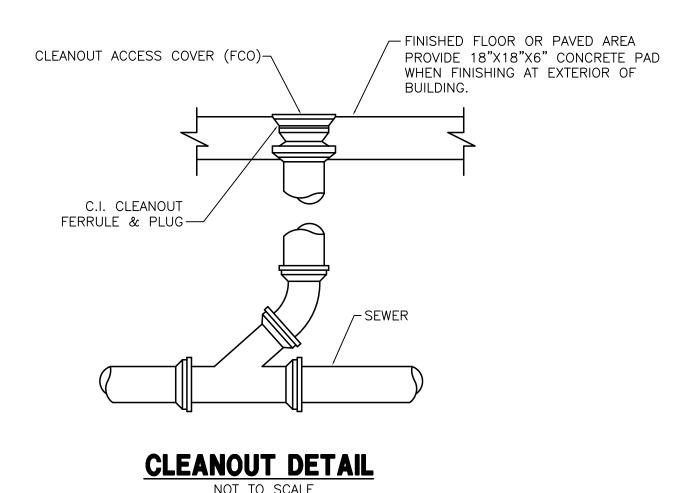

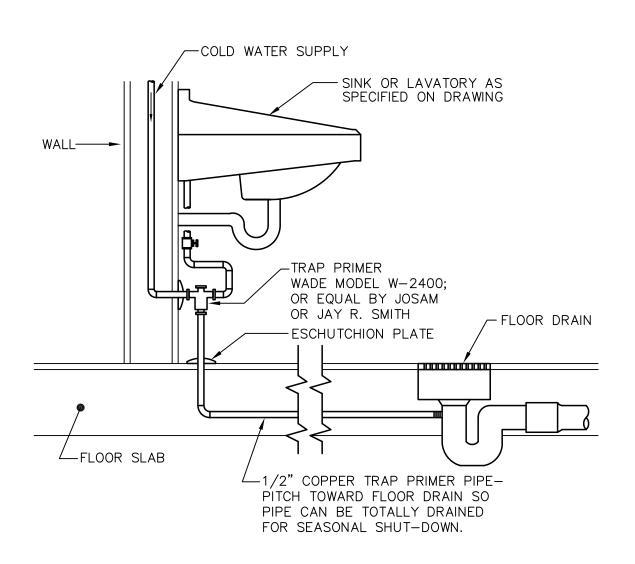


FLOOR DRAIN TRAP PRIMER DETAIL

NOT TO SCALE

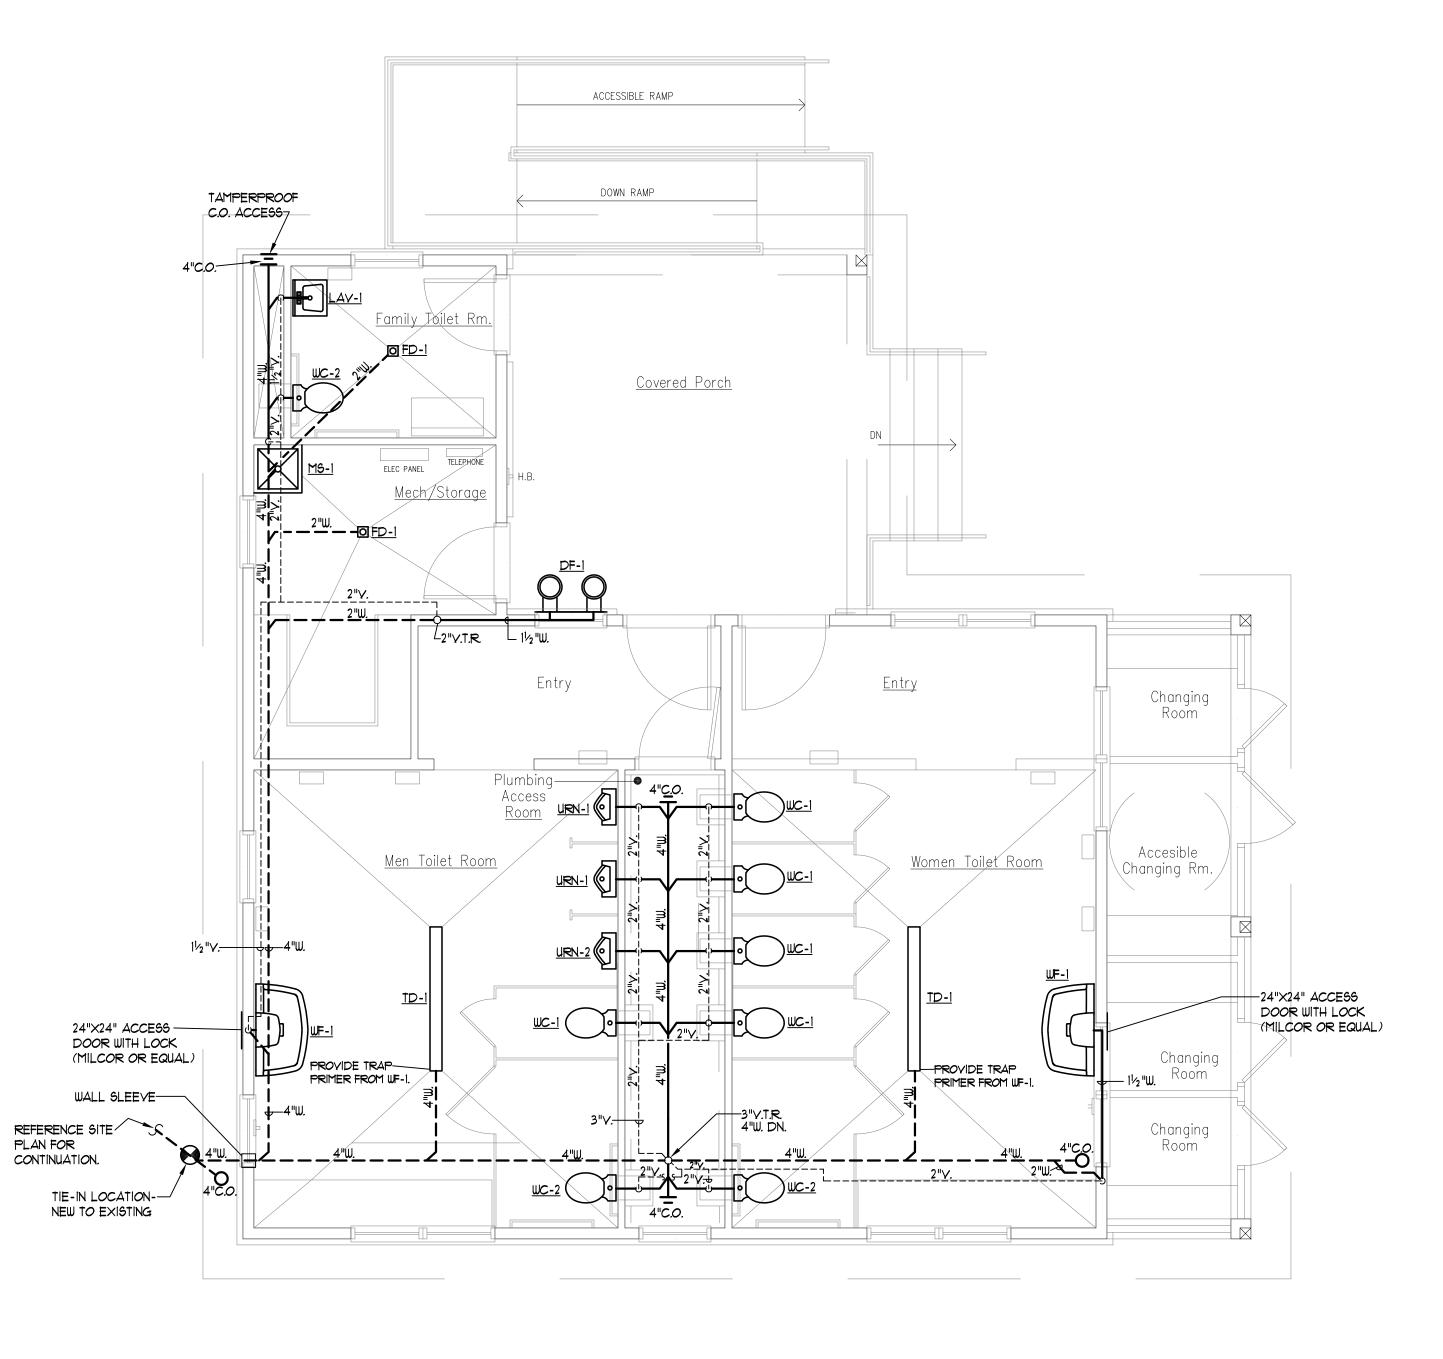

PLUMBING PLAN - WASTE AND VENT PIPING

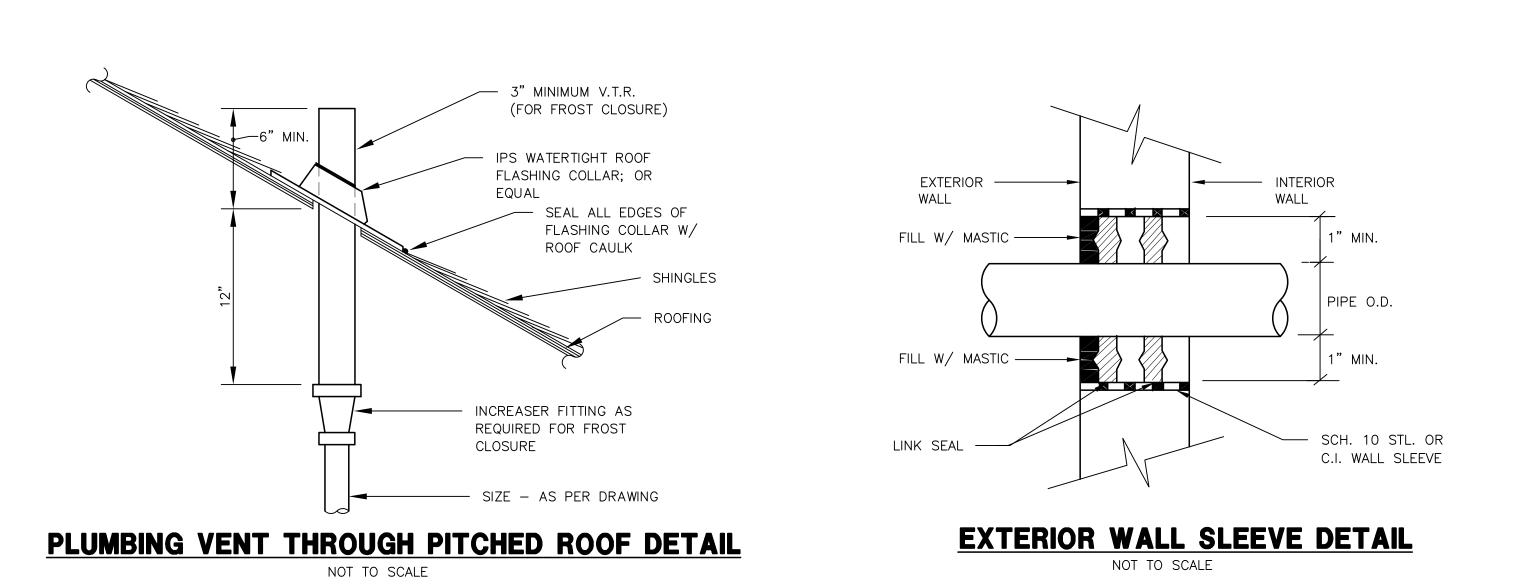

SHEET NOTES

VENT PIPING IN THE PLUMBING ACCESS ROOM SHALL BE INSTALLED SO AS NOT TO OBSTRUCT WORKER PASSAGE DOWN THE LENGTH OF THE PLUMBING CHASE.

Civil Engineer / Landscape Architect / Surveyor

2 Bedford Farms Dri
Suite 200
Bedford, NH 03110
603 391 3900

Division of Parks

and Recreation

New Hampshire

Department of Resources and

Economic Development

Division of Public Works,

Design and Construction

New Hampshire

Department of

Administrative Services

SAMYN → D'ELIA ARCHITECTS, P.A. 20 Main Street, Ashland, NH 03217 (603) 968-7133 / fax: (603) 968-3057 sdarchitects.com


Structural Engineer

Administrator



Mechanical, Electrical & Plumbing Engineer



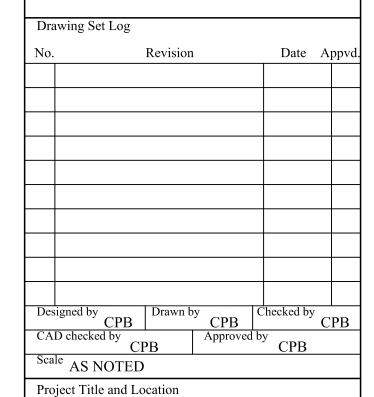

Jenness Bathhouse Replacement and Parking Lot Improvements

2280 Ocean Boulevard Rye, New Hampshire 03870

Issued fo

Construction Documents
ISSUED: June 30, 2016

Project Number

NHBPW - 80877B


Stamp


CHARLES P.
BUCKLEY
NO. 09198


PLUMBING PLAN-WASTE & VENT
PIPING &
DETAILS
Drawing Number

P-2


Sheet 2 of 3

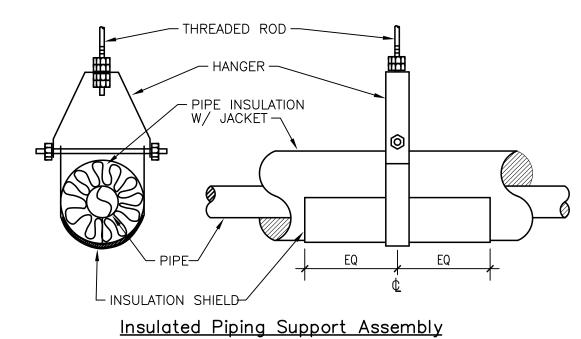

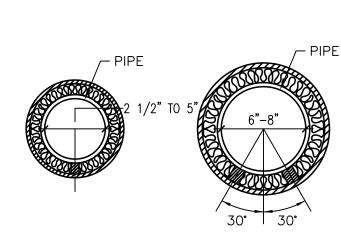

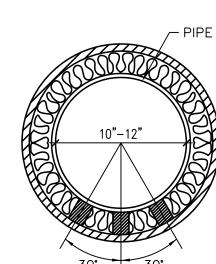


INSULATED PIPING SUPPORT ASSEMBLIES DETAIL NOT TO SCALE

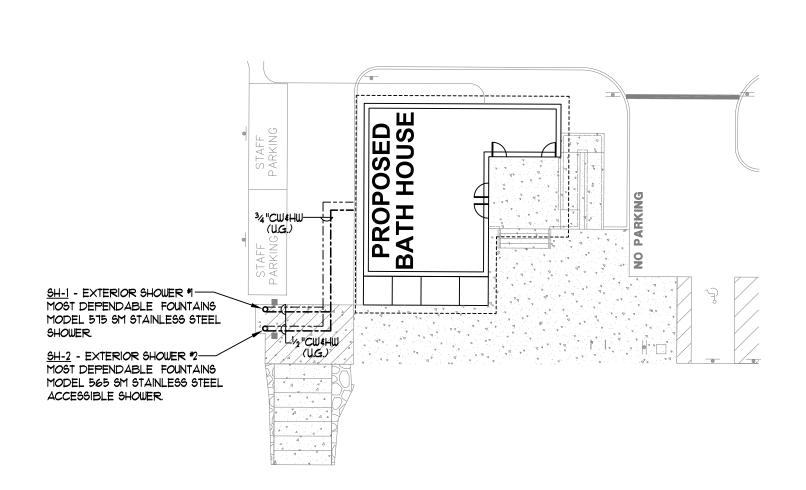


PLUMBING SITE PLAN

SCALE: 1" = 20'-0"

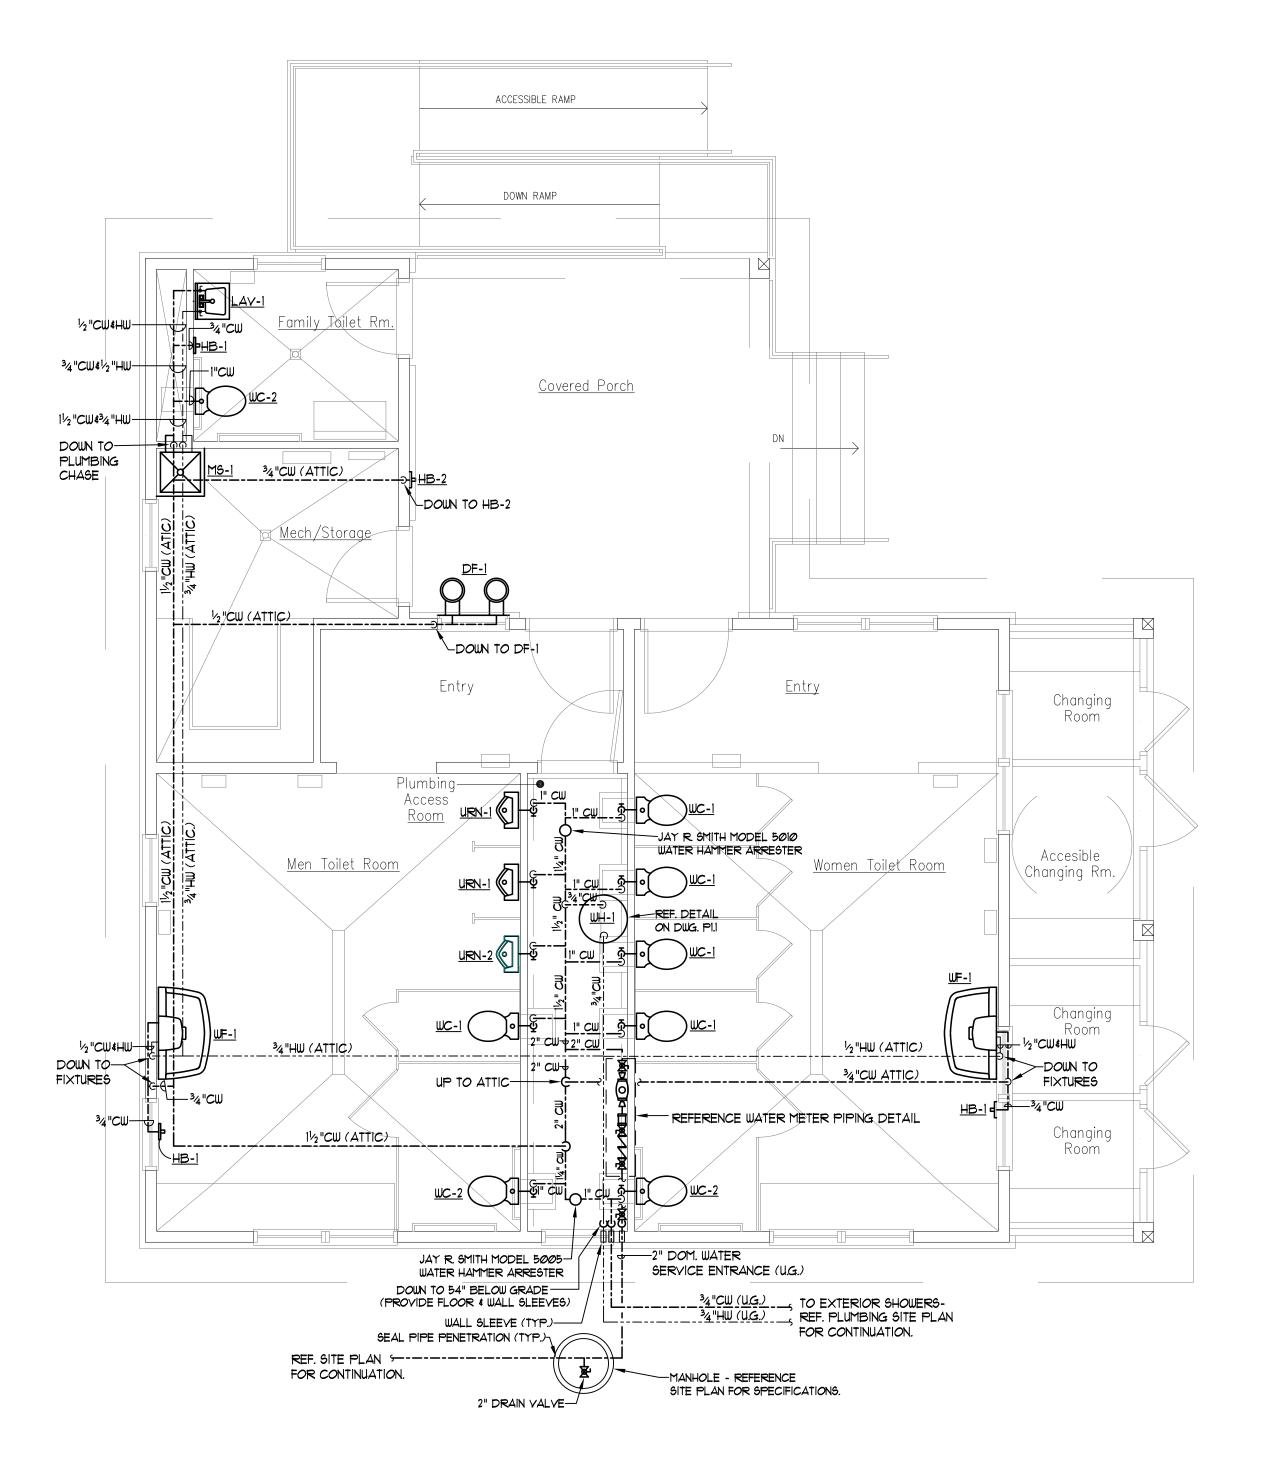

PLUMBING PLAN - DOMESTIC WATER PIPING SCALE: 1/4" = 1'-0"


SHEET NOTES

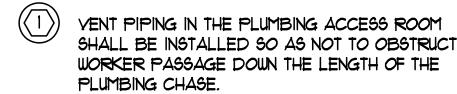

PROVIDE INDIVIDUAL SHUT-OFF VALVES FOR EACH PLUMBING FIXTURE. FOR THE TOILETS AND URINALS, LOCATE THE SHUT-OFFS IN THE PLUMBING ACCESS ROOM. WHERE POSSIBLE, USE BALL VALVES FOR THE SHUT-OFF VALVES.

SEASONAL DRAIN DOWN

ALL WATER PIPING SHALL BE INSTALLED SO AS FACILITATE SEASONAL DRAIN DOWN OF THE BUILDING'S WATER SYSTEMS. ALL PIPES SHALL BE PITCHED TO DRAIN BACK TO ACCESSIBLE LOW POINTS WHICH SHALL BE FITTED WITH BOILER DRAIN TYPE TAPS. THERE SHALL BE NO DIPS OR LOW POINTS IN THE WATER SYSTEM PIPING WITHOUT ACCESSIBLE DRAIN BACK TAPS.

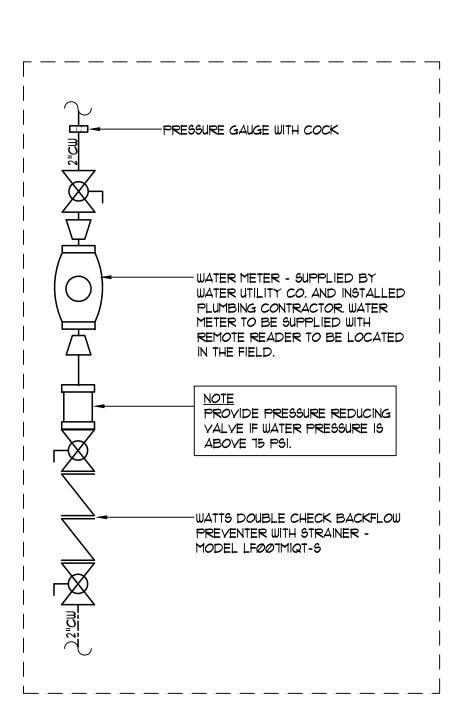

ENLARGED WATER METER PIPING DETAIL

Division of Parks
and Recreation
New Hampshire
Department of Resources and

Administrator

Division of Public Works, Design and Construction

Economic Development

New Hampshire
Department of
Administrative Services

Civil Engineer / Landscape Architect / Surveyor



2 Bedford Farms Drive Suite 200 Bedford, NH 03110 603.391.3900

SAMYN • D'ELIA ARCHITECTS, P.A. 20 Main Street, Ashland, NH 03217 (603) 968-7133 / fax: (603) 968-3057 sdarchitects.com

Structural Engineer



Mechanical, Electrical & Plumbing Engineer



No.		Revision	1	Date	Appv
Designed 1	CPB	Drawn b	CPB	Checked by	y CPB
CAD chec	Cl	PB	Approved	by CPB	
Scale AS	NOTED)			

Jenness Bathhouse Replacement and Parking Lot Improvements

2280 Ocean Boulevard Rye, New Hampshire 03870

Issued for

Construction Documents
ISSUED: June 30, 2016

Project Number

NHBPW - 80877B

Stamp

CHARLES P.
BUCKLEY
NO. 09198

PLUMBING PLAN-DOM. WATER
PIPING &
DETAILS

P-3